

#### ADDENDUM NO. 1 ISSUED JUNE 21, 2021

to

# RFP NO. 7-2021 FOR FOOD AND RETAIL CONCESSIONS OPERATIONS AT THE ERIE ISLANDS/COMMODORE PERRY SERVICE PLAZAS

PROPOSAL DUE DATE: 5:00 P.M. (EASTERN TIME), JULY 30, 2021

<u>ATTENTION OF RESPONDENTS IS DIRECTED TO:</u>
ANSWERS TO QUESTIONS RECEIVED THROUGH 12:00 PM ON JUNE 21, 2021

Issued by the Ohio Turnpike and Infrastructure Commission through Jennifer L. Stueber, Esq., General Counsel.

Jennifer L. Stueber, Esq.,

General Counsel


June 21, 2021

Date


#### ANSWERS TO QUESTIONS RECEIVED THROUGH 12:00 P.M. ON JUNE 21, 2021:

- Q#1 I am requesting an existing foodservice tenant as-built dimensioned floor plan. Thank you in advance for your assistance. This will assist us in our bidding process.
- A#1 The floor plans for the food and retail concessions units at the services plazas are issued with this Addendum No. 1.
- Q#2 We note that Common Area Maintenance Fees will be split 50:50 with the Commission. Is there an annual estimate that you can provide for these costs?
- A#2 Below is a chart showing CAM Fees billed in 2019 and MTD 2021. (2020 intentionally omitted).



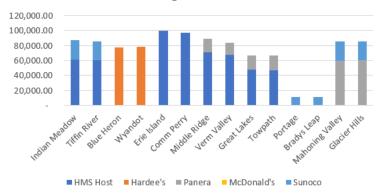

#### 2019 YTD CAM Charges Billed Thru 12/31/2019

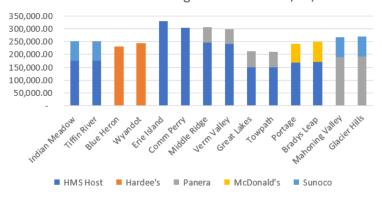

Location:	Comm Perry	Erie Island
Month	·	
Jan	\$ 25,247.24	\$ 27,015.64
Feb	24,208.92	26,153.66
Mar	24,208.92	26,153.66
Apr	25,277.08	27,973.36
May	24,925.38	28,570.28
June	26,728.58	29,802.35
July	28,983.55	30,510.03
Aug	27,620.34	30,349.08
Sept	26,267.60	28,122.38
Oct	25,230.00	27,260.27
Nov	24,419.60	25,378.62
Dec	22,065.55	23,131.86
Total	\$305,182.76	\$330,421.19

Q#3 Can the Commission provide a version of the site drawings/floor plans which includes the floor areas for the current food and beverage units at the plazas?

A#3 See response to Q#1.

**END OF ADDENDUM NO. 1** 

# OHIO TURNPIKE COMMISSION


THE JAMES W. SHOCKNESSY OHIO TURNPIKE

Milepost 100

Sandusky County, Ohio

# SERVICE PLAZA RENOVATIONS RE-BID

Erie Islands & Commodore Perry Contract No. 53-12-02

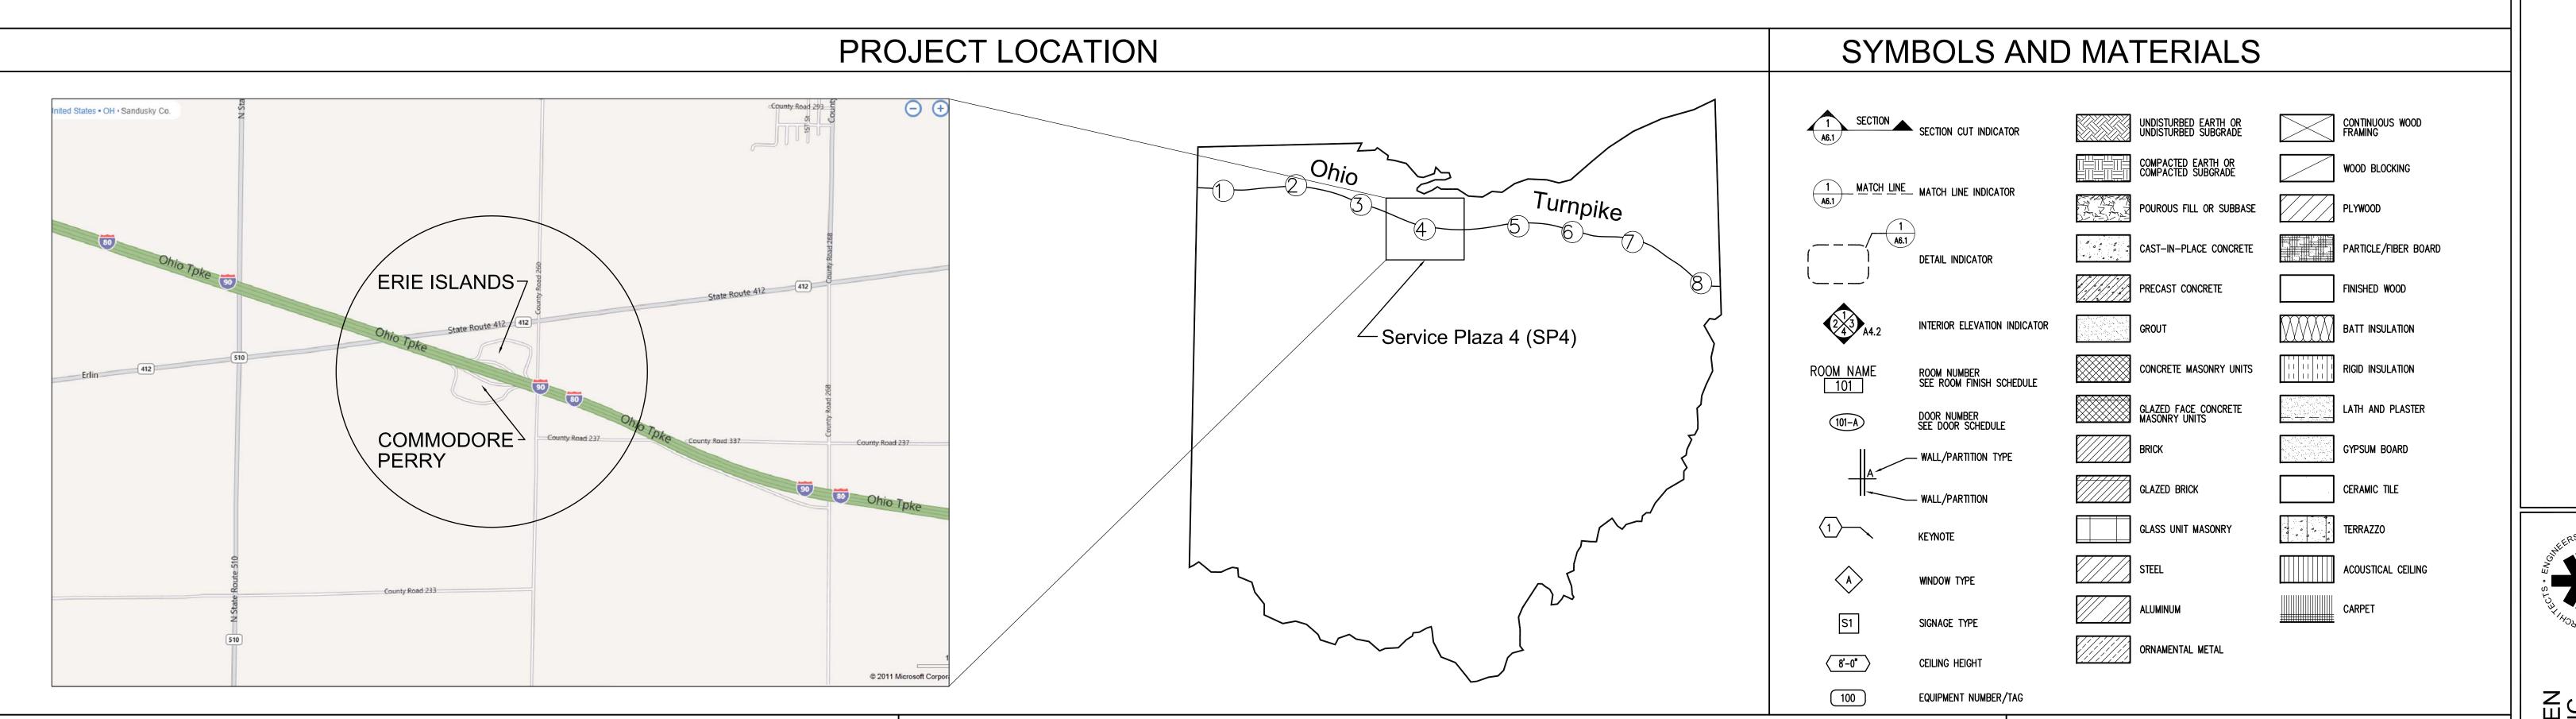

# UNDERGROUND UTILITIES TWO WORKING DAYS CALL 800-362-2764 (TOLL FREE) OHIO UTILITIES PROTECTION SERVICE NON-MEMBERS MUST BE CALLED DIRECT

APPROVED FOR THE OHIO TURNPIKE COMMISSION

CHIEF ENGINEER

DATE

		- V 17	1110110		
&	AND _	GA	GAUGE	QT	QUARRY TILE
L @	ANGLE AT	GALV GB	GALVANIZED GRAB BAR	RAD	RADIUS
Χ	BY	GC	GENERAL CONTRACTOR	RD	ROOF DRAIN
#	NUMBER	GFCMU	GROUND FACE CONCRETE MASONRY UNITS	REBAR RECT	REINFORCING BAR RECTANGULAR
A/C AB	AIR CONDITION(ER) (ING) ANCHOR BOLT	GL GLB	GLASS, GLAZING GLASS BLOCK	reinf Req	REINFORCEMENT REQUIRED
ACOUST	ACOUSTICAL	GLCMU	GLAZED FACE CONCRETE	REP	REPRESENTATIVE
ACT ADJ	ACOUSTICAL CEILING TILE ADJUSTABLE	GYPLS	MASONRY UNITS GYPSUM PLASTER	RFG RM	RECESSED FOOT GRILLE ROOM
AFF	ABOVE FINISHED FLOOR	GWB	GYPSUM WALL BOARD	R/W	RIGHT-OF-WAY
ALT ALUM	ALTERNATE ALUMINUM	GTC	GENERAL TRADES CONTRACTOR	RWC	RAIN WATER CONDUCTOR
APPROX ARCH	APPROXIMATELY ARCHITECTURAL	H HC	HIGH, HEIGHT HANDICAPPED	S/H SC	SEALER/HARDENER SOLID CORE
AESS	ARCHITECTURALLY EXPOSED	HD	HAND DRYER	SF	SQUARE FOOT
	STRUCTURAL STEEL	HDWE HDWD	HARDWARE HARDWOOD	SFCMU	SPLIT FACE CONCRETE MASONRY UNITS
BLDG	BUILDING	HM	HOLLOW METAL	SGB	STRUCTURAL GLAZED BLOCK
BLKG B <b>M</b>	BLOCKING Beam	Horiz Hr	HORIZONTAL(LY) HOUR	SIM SK	SIMILAR SINK
BR	BRICK	HVAC	HEATING, VENTILATING, AIR CONDITIONING	SOG SPEC	SLAB ON GRADE SPECIFICATIONS
BRG BTM	BEARING BOTTOM			SQ	SQUARE
BUR	BUILT UP ROOFING	ID INSUL	INSIDE DIAMETER INSULATION	SRGB SS	SAG-RESISTANT GYPSUM BOARD STAINLESS STEEL
C/C	CENTER TO CENTER	INT	INTERIOR	STC	SOUND TRANSMISSION CLASS
CĴ C/L	CONSTRUCTION JOINT CENTER LINE	INTERMED INV	INTERMEDIATE INVERT	STD STL	STANDARD STEEL
C/L CAR	CENTER LINE	IRWC	IMPACT RESISTANT WALLCOVERING	STOR STRUCT	STORAGE STRUCTURAL
CAR CBB	CARPET (ROLL GOODS/BROADLOOM) CEMENTITIOUS BACKER BOARD	JAN	JANITOR	SUPPL	SUPPLEMENTARY
CCT CLG	CUBICLE CURTAIN TRACK	JB JT	JUNCTION BOX JOINT	SUSP SV	Suspended Sheet vinyl
CLO	CEILING CLOSET			SVT	SOLID VINYL TILE
CMU COL	CONCRETE MASONRY UNIT COLUMN	LAM LAV	LAMINATED LAVATORY	TEMP	TEMPERED
CONC	CONCRETE	lf Lin	LINEAR FEET LINOLEUM	T/BM T&G	TOP OF BEAM TONGUE AND GROOVE
CONF CONST	CONFERENCE CONSTRUCTION	LLH	LONG LEG HORIZONTAL	THR	THRESHOLD
CONT CONTR	CONTINUOUS CONTRACTOR	LLV	LONG LEG VERTICAL	T/JST TKBD	TOP OF JOIST TACK BOARD
CORR	CORRIDOR	M Maint	MIRROR MAINTENANCE	TOM TOS	TOP OF MASONRY TOP OF SLAB
CPT CRS	CARPET TILE COURSE	MATL	MATERIAL	T/ST	TOP OF STEEL
CT	CERAMIC TILE	MAX MECH	MAXIMUM MECHANICAL	TTD TYP	TOILET TISSUE DISPENSER TYPICAL
DBL	DOUBLE	MET MFR	METAL MANUFACTURER	UNO	UNLESS NOTED OTHERWISE
DEM DF	DEMISING DRINKING FOUNTAIN	MH	MANHOLE		
DIA	DIAMETER	MIN MO	MINIMUM MASONRY OPENING	V VCT	VINYL VINYL COMPOSITION TILE
DIM DN	DIMENSION Down	MOULD MTD	MOULDING MOUNTED	VERT VEST	VERTICAL VESTIBULE
DS DP	DOWN SPOUT DEEP	MC	MECHANICAL/HVAC CONTRACTOR		
DR	DOOR	NIC	NOT IN CONTRACT	W/ WC	WITH WATER CLOSET
DET DWG	DETAIL Drawing	NO.	NUMBER	WD	WOOD
EA	EACH	NOM NTS	NOMINAL NOT TO SCALE	W/O WR	WITHOUT WASTE RECEPTACLE
EF	EACH FACE	OC	ON CENTER	WPT WWF	WOOD — PRESERVATIVE TREATED WELDED WIRE FABRIC
E.J. EL	EXPANSION JOINT ELEVATION	OD	OUTSIDE DIAMETER	*****	WEEDED WINE PARKS
ELEC ELEV	ELECTRICAL ELEVATION	opng opp	OPENING OPPOSITE		
ENCL	ENCLOSED (SURE)	ORD	OVERFLOW ROOF DRAIN		
EQ EQUIP	EQUAL EQUIPMENT	PART'N	PARTITION		
ETC EW	ET CETERA EACH WAY	PERIM PL	PERIMETER PLATE		
EWC	ELECTRIC WATER COOLER	P/L PLAM	PROPERTY LINE PLASTIC LAMINATE		
EXIST EXT	Existing Exterior	PLBG	PLUMBING		
EC	ELECTRICAL CONTRACTOR	PLS PNL	PLASTER PANEL		
FD	FLOOR DRAIN	PTD	PAINTED (PAINTED FINISH)		
FE FEC	FIRE EXTINGUISHER FIRE EXTINGUISHER CABINET	PR PROJ	PAIR PROJECT		
FH	FIRE HYDRANT	PT PLYWD	PRESSURE TREATED PLYWOOD		
FHC FIN	FIRE HOSE CABINET FINISH	PC	PLUMBING CONTRACTOR		
FIXT FL	Fixture Floor				
FLDR	FOLDING DOOR				
FM FR	FACTORY MUTUAL FIRE RATED				
FRTW FSS	FIRE RETARDANT TREATED WOOD FOLDING SHOWER SEAT				
FT	FOOT				
FTG	FOOTING				

1. FOR ADDITIONAL REFERENCE THE CONSTRUCTION INDUSTRY STANDARDS -

2. THIS LEGEND DOES NOT ASSUME THAT ALL ABBREVIATIONS ARE USED.

C.S.I DOCUMENT TD -2-4 ABBREVIATIONS.

**ABBREVIATIONS** 

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	SITE ELECTRICAL PLANS - FOR INFORMATION ONLY	(2 SHEETS)

#### PROJECT TEAM

#### **OWNER** THE OHIO TURNPIKE COMMISSION 682 PROSPECT STREET BEREA, OHIO 44107 440.234.2081 (PH) 440.234.4582 (FAX)

#### **ARCHITECT** RICHARD L. BOWEN + ASSOCIATES INC. 13000 SHAKER BOULEVARD CLEVELAND, OHIO 44120 216.491.9300 (PH)

216.491.8053 (FAX)

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7/6/12 BID & PERMIT 9/10/12 RE-BID

No. Date/Description

DATES AND REVISIONS

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			ROC	OM FINISH SCI	HEDULE		
ROOM NO.	ROOM NAME	FLOOR	BASE	WALLS	CEILING	REMARKS	ROOM NO.
BASEME	NT LEVEL						
100 101 102 103 104	CORRIDOR MECHANICAL ELECTRICAL ROOM CORRIDOR STORAGE	ETR ETR ETR ETR ETR ETR	ETR ETR ETR ETR ETR ETR	ETR ETR ETR ETR ETR ETR	ETR ETR ETR ETR ETR ETR		100 101 102 103 104
105 106 107 108 108A	VENDOR STORAGE SUPPLY ROOM/OFFICE ELEVATOR EQUIPMENT MEN JANITOR	ETR ETR 105 106 107 108 108A
109 110 111 112 113	WOMEN BREAK ROOM TELEPHONE EQUIPMENT OFFICE ELECTRICAL	ETR ETR ETR ETR ETR ETR	ETR ETR ETR ETR ETR ETR	ETR ETR ETR ETR ETR ETR	ETR ETR ETR ETR ETR ETR		109 110 111 112 113
114 115 116 117 ST-A ST-B	CORRIDOR SERVICE LOBBY STORAGE AREAWAY STAIR 'A' STAIR 'B'	ETR ETR 114 115 116 117 ST-A ST-B
FIRST FL							
200 201 202 203 205	AUTO ENTRY PHONES LOBBY SOUTH VENDING GAME ROOM	ETR ETR ETR ETR ETR ETR	ETR ETR ETR ETR ETR	ETR PAINT ALL ALCOVE WALLS (PT-4) ETR PAINT ALL ALCOVE WALLS (PT-2) PAINT ALL ALCOVE WALLS (PT-8)	EXST. GYP. BD. PAINT (PT-1) ETR NEW WORK: SEE SHT. A2.0 EXST. GYP. BD. PAINT (PT-1) EXST. GYP. BD. PAINT (PT-1)	PAINT CABINET HEATER (PT-1) REPAIR WALLS AS REQ'D PRIOR TO PAINTING  CONTRACTOR TO MOVE VENDING MACHINES OWNER WILL RELOCATE GAME MACHINES	200 201 202 203 205
206 207 208 209 210	LOBBY NORTH AUTO ENTRY NOT USED WOMEN'S CORRIDOR JANITOR	ETR ETR ETR ETR	ETR ETR ETR ETR	ETR ETR ETR ETR	NEW WORK: SEE SHT. A2.0 EXST. GYP. BD. PAINT (PT-1)  EXST. GYP. BD. PAINT (PT-1) ETR	PAINT CABINET HEATER (PT-1)	206 207 208 209 210
211 212 213 214 215	WOMEN'S WEST WOMEN'S EAST MEN'S CORRIDOR MEN'S WEST MEN'S EAST	ETR ETR ETR ETR ETR ETR	ETR ETR ETR ETR ETR ETR	ETR ETR ETR ETR ETR ETR	EXST. GYP. BD. PAINT (PT-1)	SEE INTERIOR ELEVATIONS SEE INTERIOR ELEVATIONS SEE INTERIOR ELEVATIONS SEE INTERIOR ELEVATIONS	211 212 213 214 215
216 217 218 219 220	JANITOR FAMILY/UNISEX RESTROOM TRUCKER CORRIDOR TRUCKER ENTRY TRUCKER LOUNGE	ETR ETR ETR ETR ETR ETR NEW CARPET TILES: CPT-1	ETR ETR ETR ETR CTB-1	ETR ETR PAINT - SEE ELEVATIONS ETR EXST. GYP. BD. PAINT (PT-1)	ETR  EXST. GYP. BD. PAINT (PT-1)  NEW WORK: SEE SHT. A2.0  EXST. GYP. BD. PAINT (PT-1)  NEW WORK: SEE SHT. A2.0		216 217 218 219 220
221 222 223 224 225	HOUSE LAUNDRY TRUCKER LAUNDRY CORRIDOR TRUCKER SHOWER TRUCKER SHOWER	ETR ETR ETR ETR ETR ETR	ETR ETR ETR ETR ETR ETR	ETR EXST. GYP. BD. PAINT (PT-1) EXST. GYP. BD. PAINT (PT-1) ETR ETR	ETR ETR NEW WORK: SEE SHT. A2.0 EXST. GYP. BD. PAINT (PT-1) EXST. GYP. BD. PAINT (PT-1)	NEW COUNTER TOP & SUPPORT BRACKETS	221 222 223 224 225
226 227 229 230 231	TRUCKER SHOWER TRUCKER SHOWER VENDOR CORRIDOR OTC OFFICE VEHICLE MAINTENANCE	ETR ETR ETR ETR ETR ETR	ETR ETR NEW RB-1 ETR ETR	ETR ETR ETR ETR ETR ETR	EXST. GYP. BD. PAINT (PT-1)  EXST. GYP. BD. PAINT (PT-1)  NEW WORK: SEE SHT. A2.0  ETR  ETR	EXST. FRP WALL PANELS TO REMAIN	226 227 229 230 231
232 233 234 235 236	YARD MAINTENANCE RECEIVING BAY RECEIVING DOCK SERVICE LOBBY COMMUNICATIONS	ETR ETR 232 233 234 235 236
237 238 239 240 241	VESTIBULE JANITOR OFFICE FIRE PUMP ROOM FOOD VENDOR PREP AREA	ETR ETR NEW VCT-1 ETR ETR	NEW RB-1 ETR NEW RB-1 ETR ETR	EXST. PAINT (PT-1) ETR ETR ETR ETR ETR	NEW WORK: SEE SHT. A2.0  ETR  NEW ACT-1  ETR  ETR	CEILING IN NEW 2x2 GRID SYSTEM	237 238 239 240 241
242 243 244 245 251	FOOD SERVICE FOOD COURT BUS ENTRY CORRIDOR INFO ALCOVE/KIOSK	ETR ETR ETR ETR	ETR ETR ETR ETR ETR	SEE INTERIOR ELEVATIONS SEE INTERIOR ELEVATIONS ETR SEE INTERIOR ELEVATIONS PAINT ALL ALCOVE WALLS (PT. 2)	NEW WORK: SEE SHT. A2.0  NEW WORK: SEE SHT. A2.0  EXST. GYP. BD. PAINT (PT-1)  NEW WORK: SEE SHT. A2.0	SEE OTHER ARCH. DWGS. SEE OTHER ARCH. DWGS. SEE OTHER ARCH. DWGS. SEE OTHER ARCH. DWGS.	242 243 244 245 251
ST-A ST-B	STAIR A STAIR B	ETR ETR ETR	ETR ETR	PAINT ALL ALCOVE WALLS (PT-2)  ETR  ETR	NEW WORK: SEE SHT. A2.0  ETR  ETR	PAINT ALL METAL ITEMS (PT-3) PAINT ALL METAL ITEMS (PT-3)	ST-A ST-B
						, ,	


PAINT COLORS									
PT-1	SW 7005 "PURE WHITE"								
PT-2	SW 6127 "IVOIRE"								
PT-3	TO BE SELECTED BY ARCHITECT								
PT-4	SW 7036 "ACCESSIBLE BEIGE"								
PT-5	SW 6126 "NAVAJO WHITE"								
PT-6	SW 6106 "KILIM BEIGE"								
PT-7	(NOT USED)								
PT-8	SW 6107 "NOMADIC DESERT"								
PT-9	SW 6201 "THUNDEROUS"								

NOTE: COLORS BASED ON SHERWIN WILLIAMS PRODUCTS

PLAST	PLASTIC LAMINATE									
PL-1 PL-2	WILSONART 1530-60 "BEIGE" WILSONART 4143-60 "NEUTRAL GLACE"									
FL=2	WILSUNART 4145-00 NEUTRAL GLACE									

CARPET TILE										
CPT-1	C&A TANDRUS — STYLE: 05175 "EXPLORER" COLOR: 25007 "NILE BROWN"									

ABREVIATIONS							
ACT	ACOUSTIC CEILING TILE						
CMT	CERAMIC MOSAIC TILE						
PL	PLASTIC LAMINATE						
CMU	CONCRETE MASONRY UNIT						
CPT	CARPET TILE						
СТ	CERAMIC TILE						
PT	PAINT						
EXP	EXPOSED						
GYP. BD.	GYPSUM BOARD						
RB	RUBBER BASE						
EXST	EXISTING						
SSM	SOLID SURFACE MATERIAL						
VCT	VINYL COMPOSITE TILE						
ETR	EXISTING TO REMAIN						

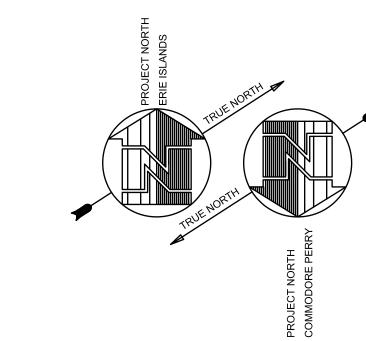



#### GENERAL FLOOR PLAN NOTES:

- 1. ALL CONTRACTORS SHALL VERIFY EXISTING CONDITIONS TO ENSURE THAT THE NEW WORK WILL FIT TO THE EXISTING STRUCTURE IN THE MANNER INTENDED AND SHOWN ON THE DRAWINGS. FIELD VERIFY. SHOULD ANY CONDITIONS EXIST THAT ARE CONTRARY TO THOSE SHOWN ON THE DRAWINGS, THE CONTRACTOR SHALL NOTIFY THE ARCHITECT AND/OR OWNER PRIOR TO PERFORMING ANY WORK.
- 2. ITEMS NOTED TO BE "REPAINTED" SHALL HAVE THEIR SURFACES AND SUBSTRATES PROPERLY PREPARED TO RECEIVE THE NEW SPECIFIED FINISH.

#### PAINTING INFORMATION:

- 1. ALL INTERIOR EXISTING HOLLOW METAL DOORS AND FRAMES TO BE PAINTED. COLOR TO BE PT-6.
- 2. SEE ROOM FINISH SCHEDULE FOR ADDITIONAL PAINTING INFORMATION.
- 3. OUTSIDE FACE OF ALL EXTERIOR HOLLOW METAL DOORS AND FRAMES TO BE PAINTED. COLOR TO BE PT-5.

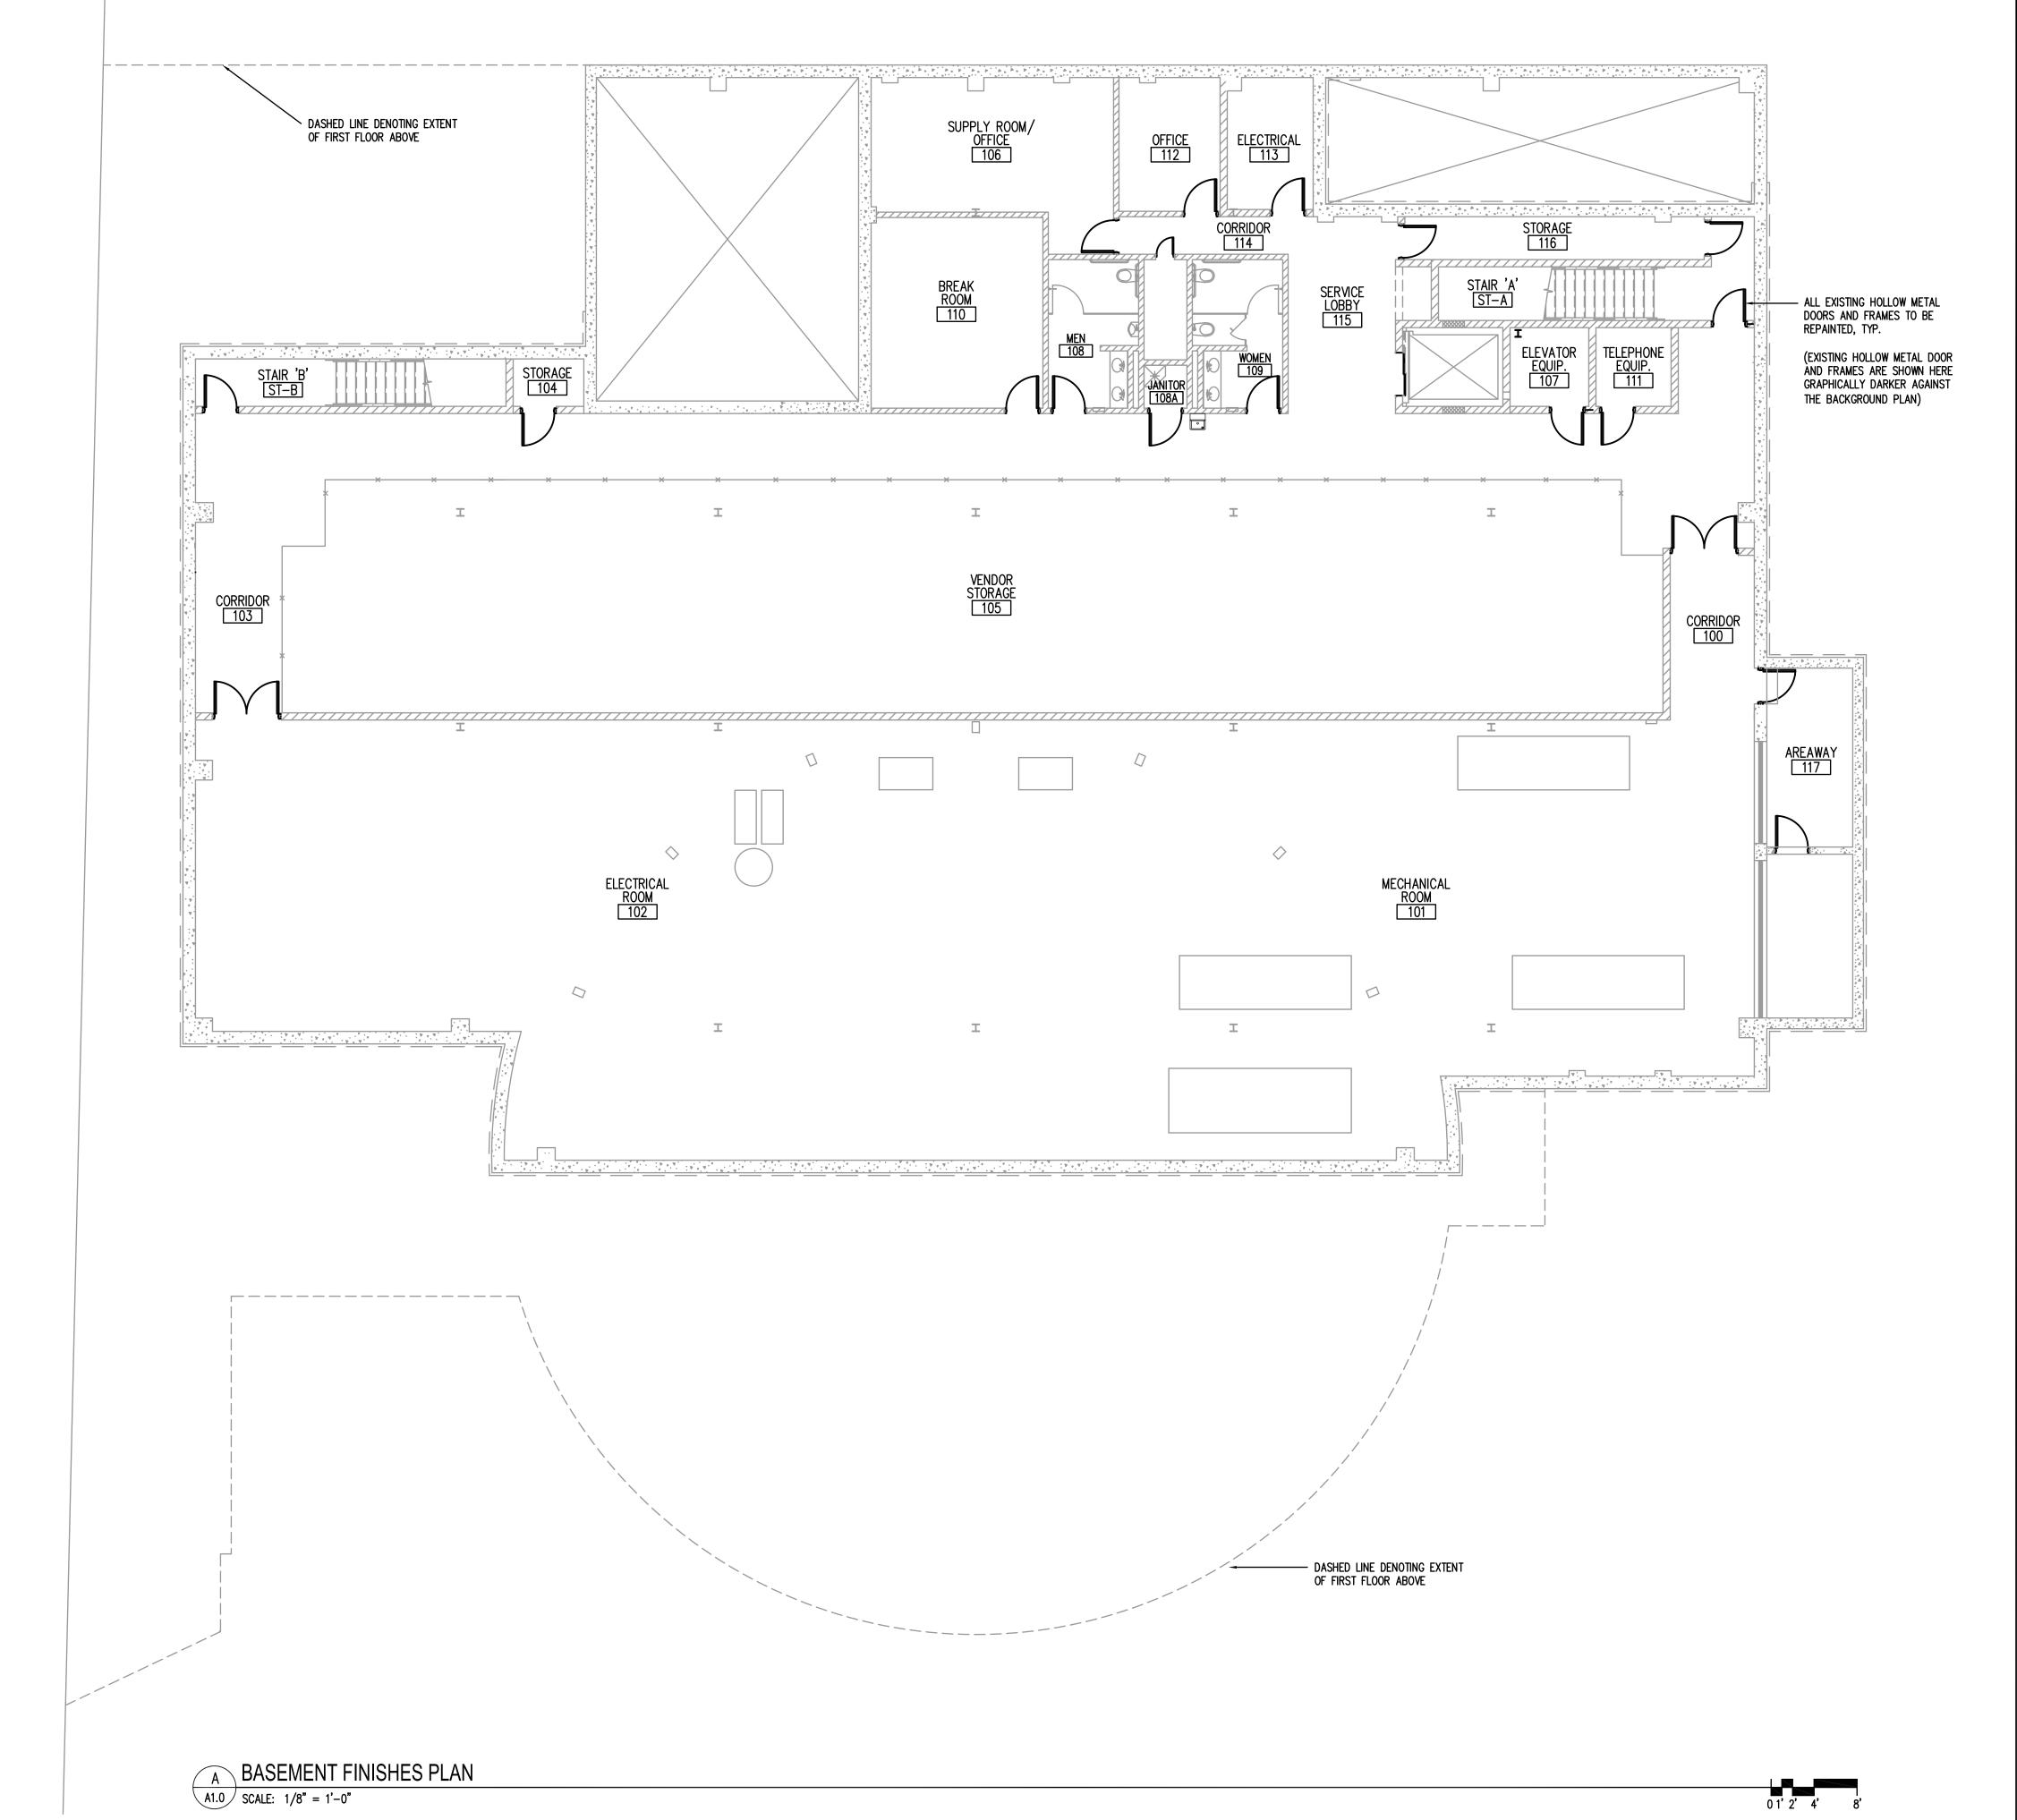

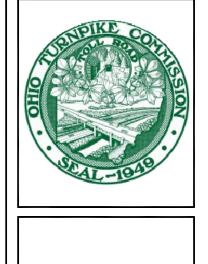

DATES AND REVISIONS

7/6/12 BID & PERMIT 9/10/12 RE-BID

No. Date/Description

D L. BOWEN
CIATES INC.

System / Cleveland, Ohio 44120
69300 Fax: (216) 491-8053
om - email@rlba.com

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ERVICE PLAZA RENOVATIONS

Erie Islands and Commodore Perry

Milepost 100 - Sandusky County, Ohio


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CHECKED BY: KJE
RLB NO.: 6744.09

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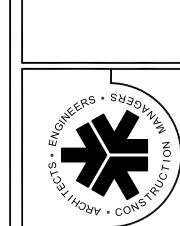
SERVICE SP-4

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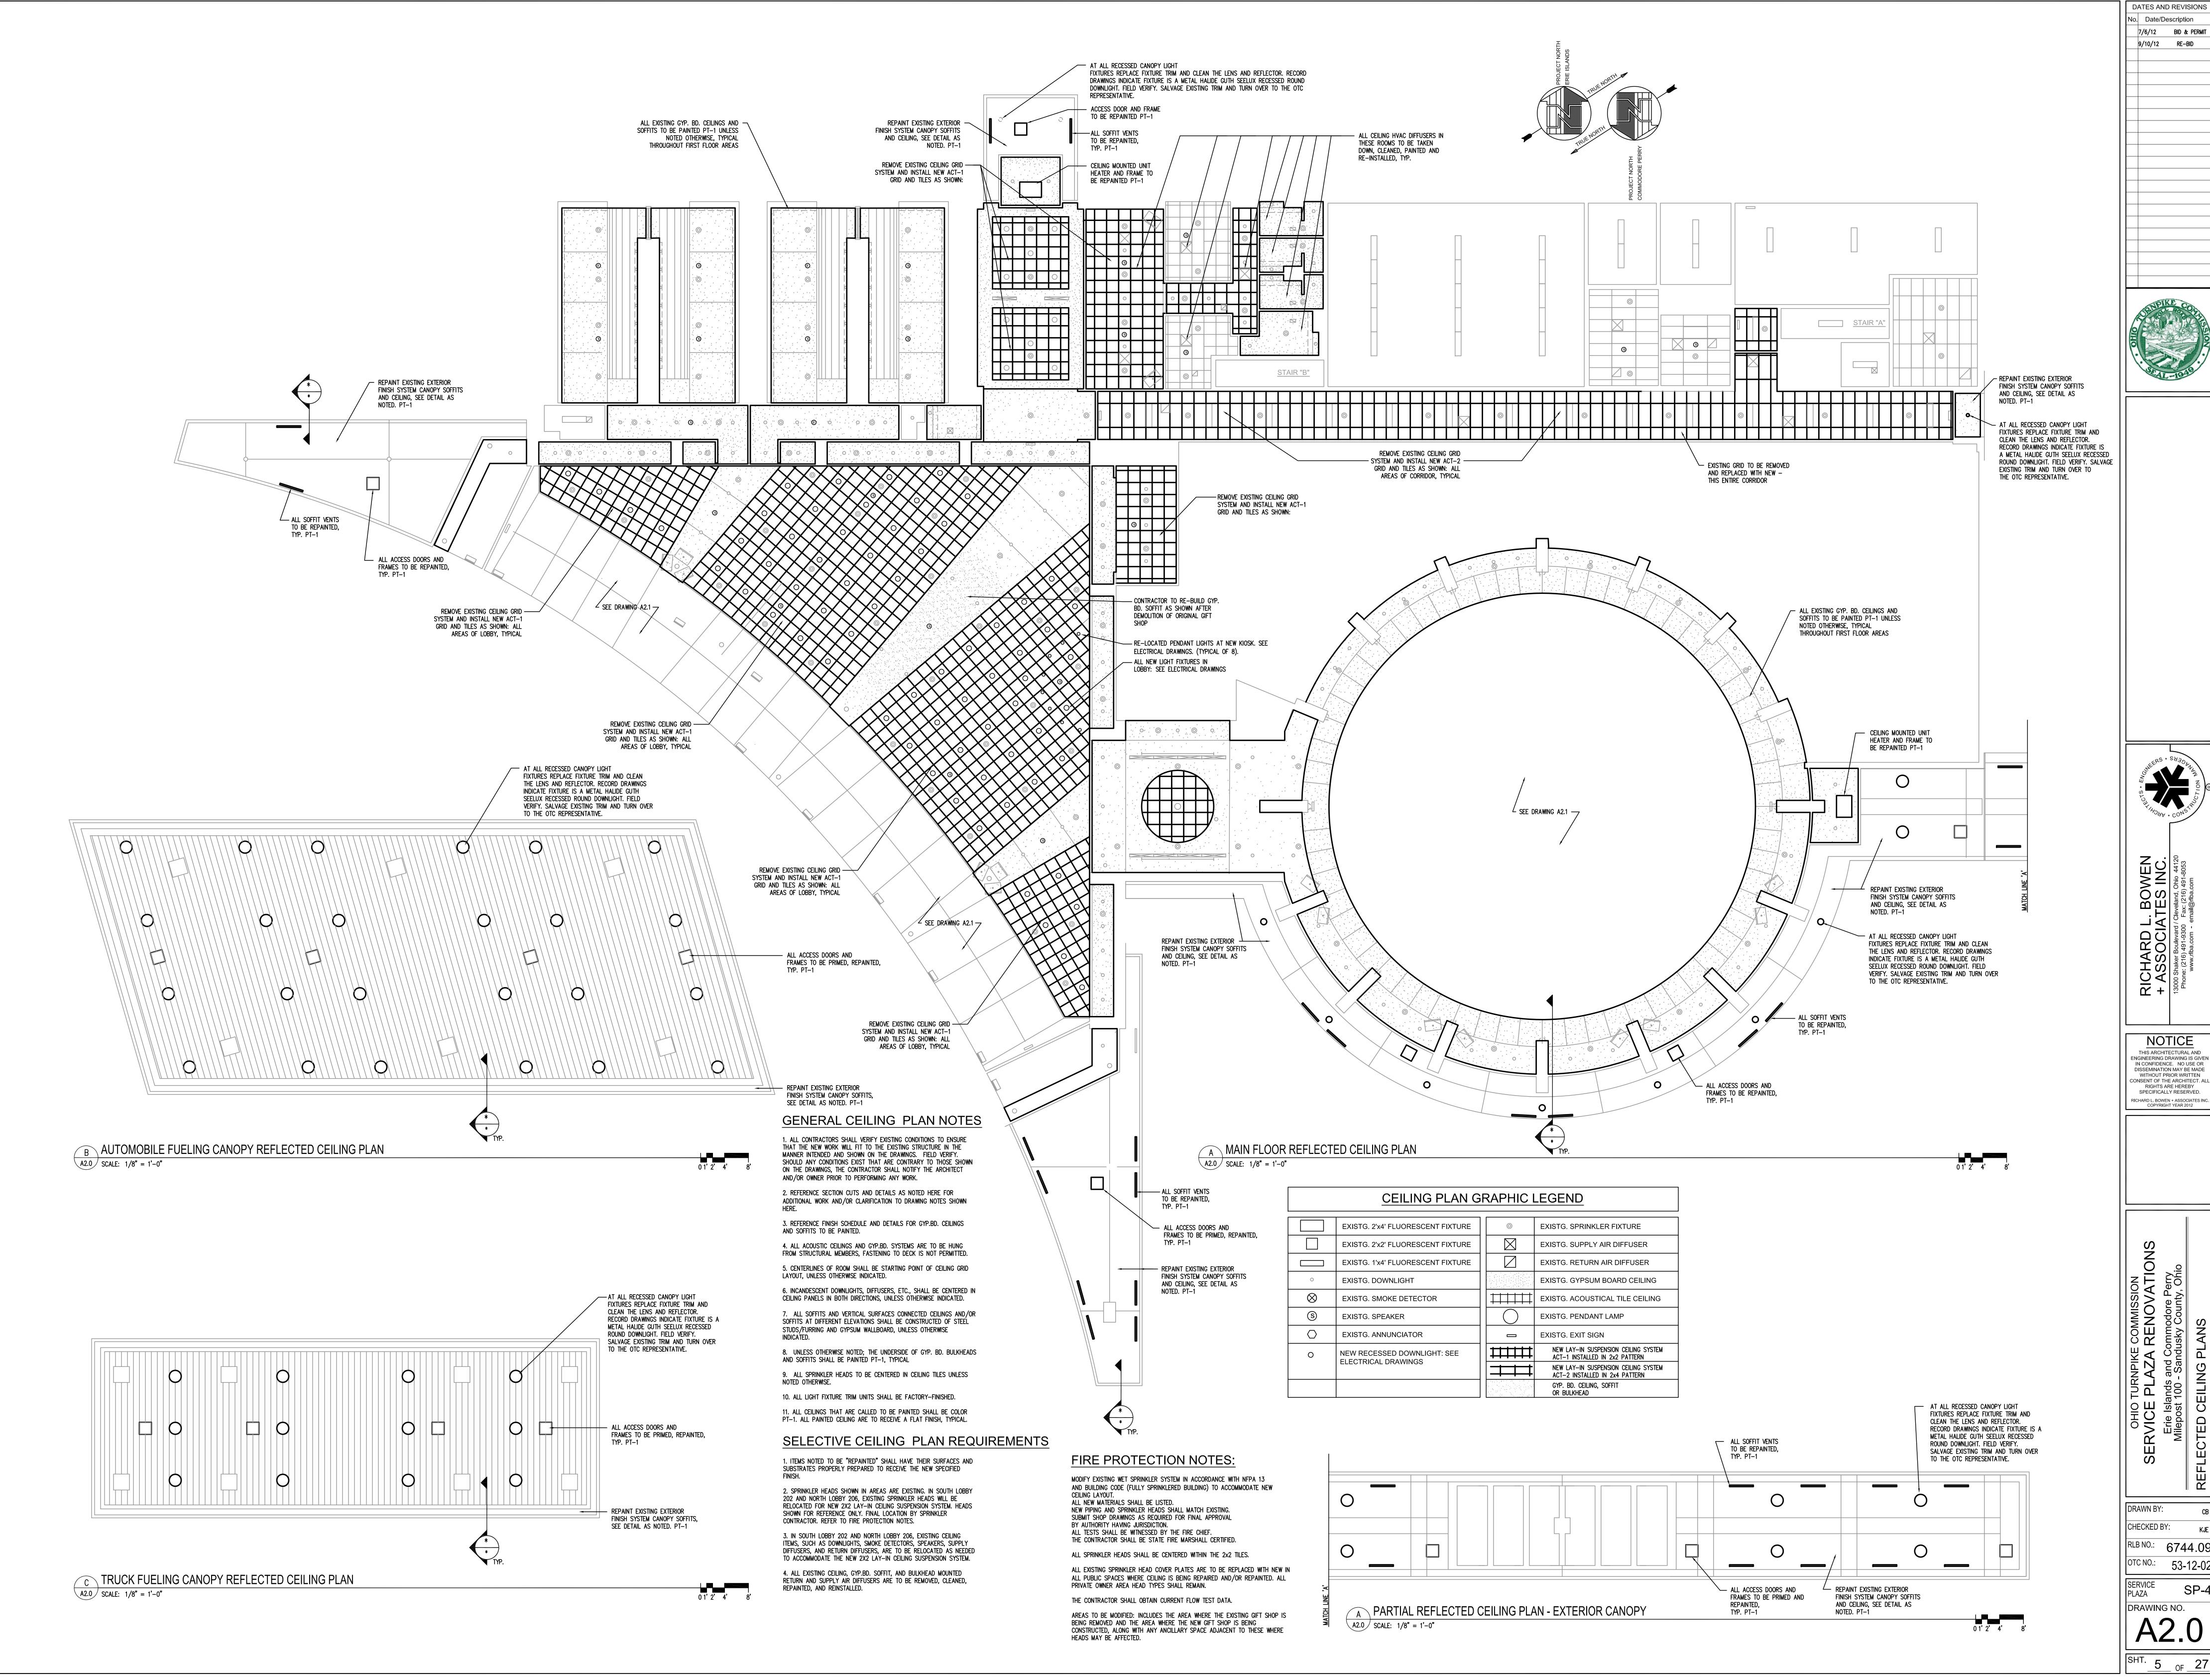
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No. Date/Description 7/6/12 BID & PERMIT 9/10/12 RE-BID



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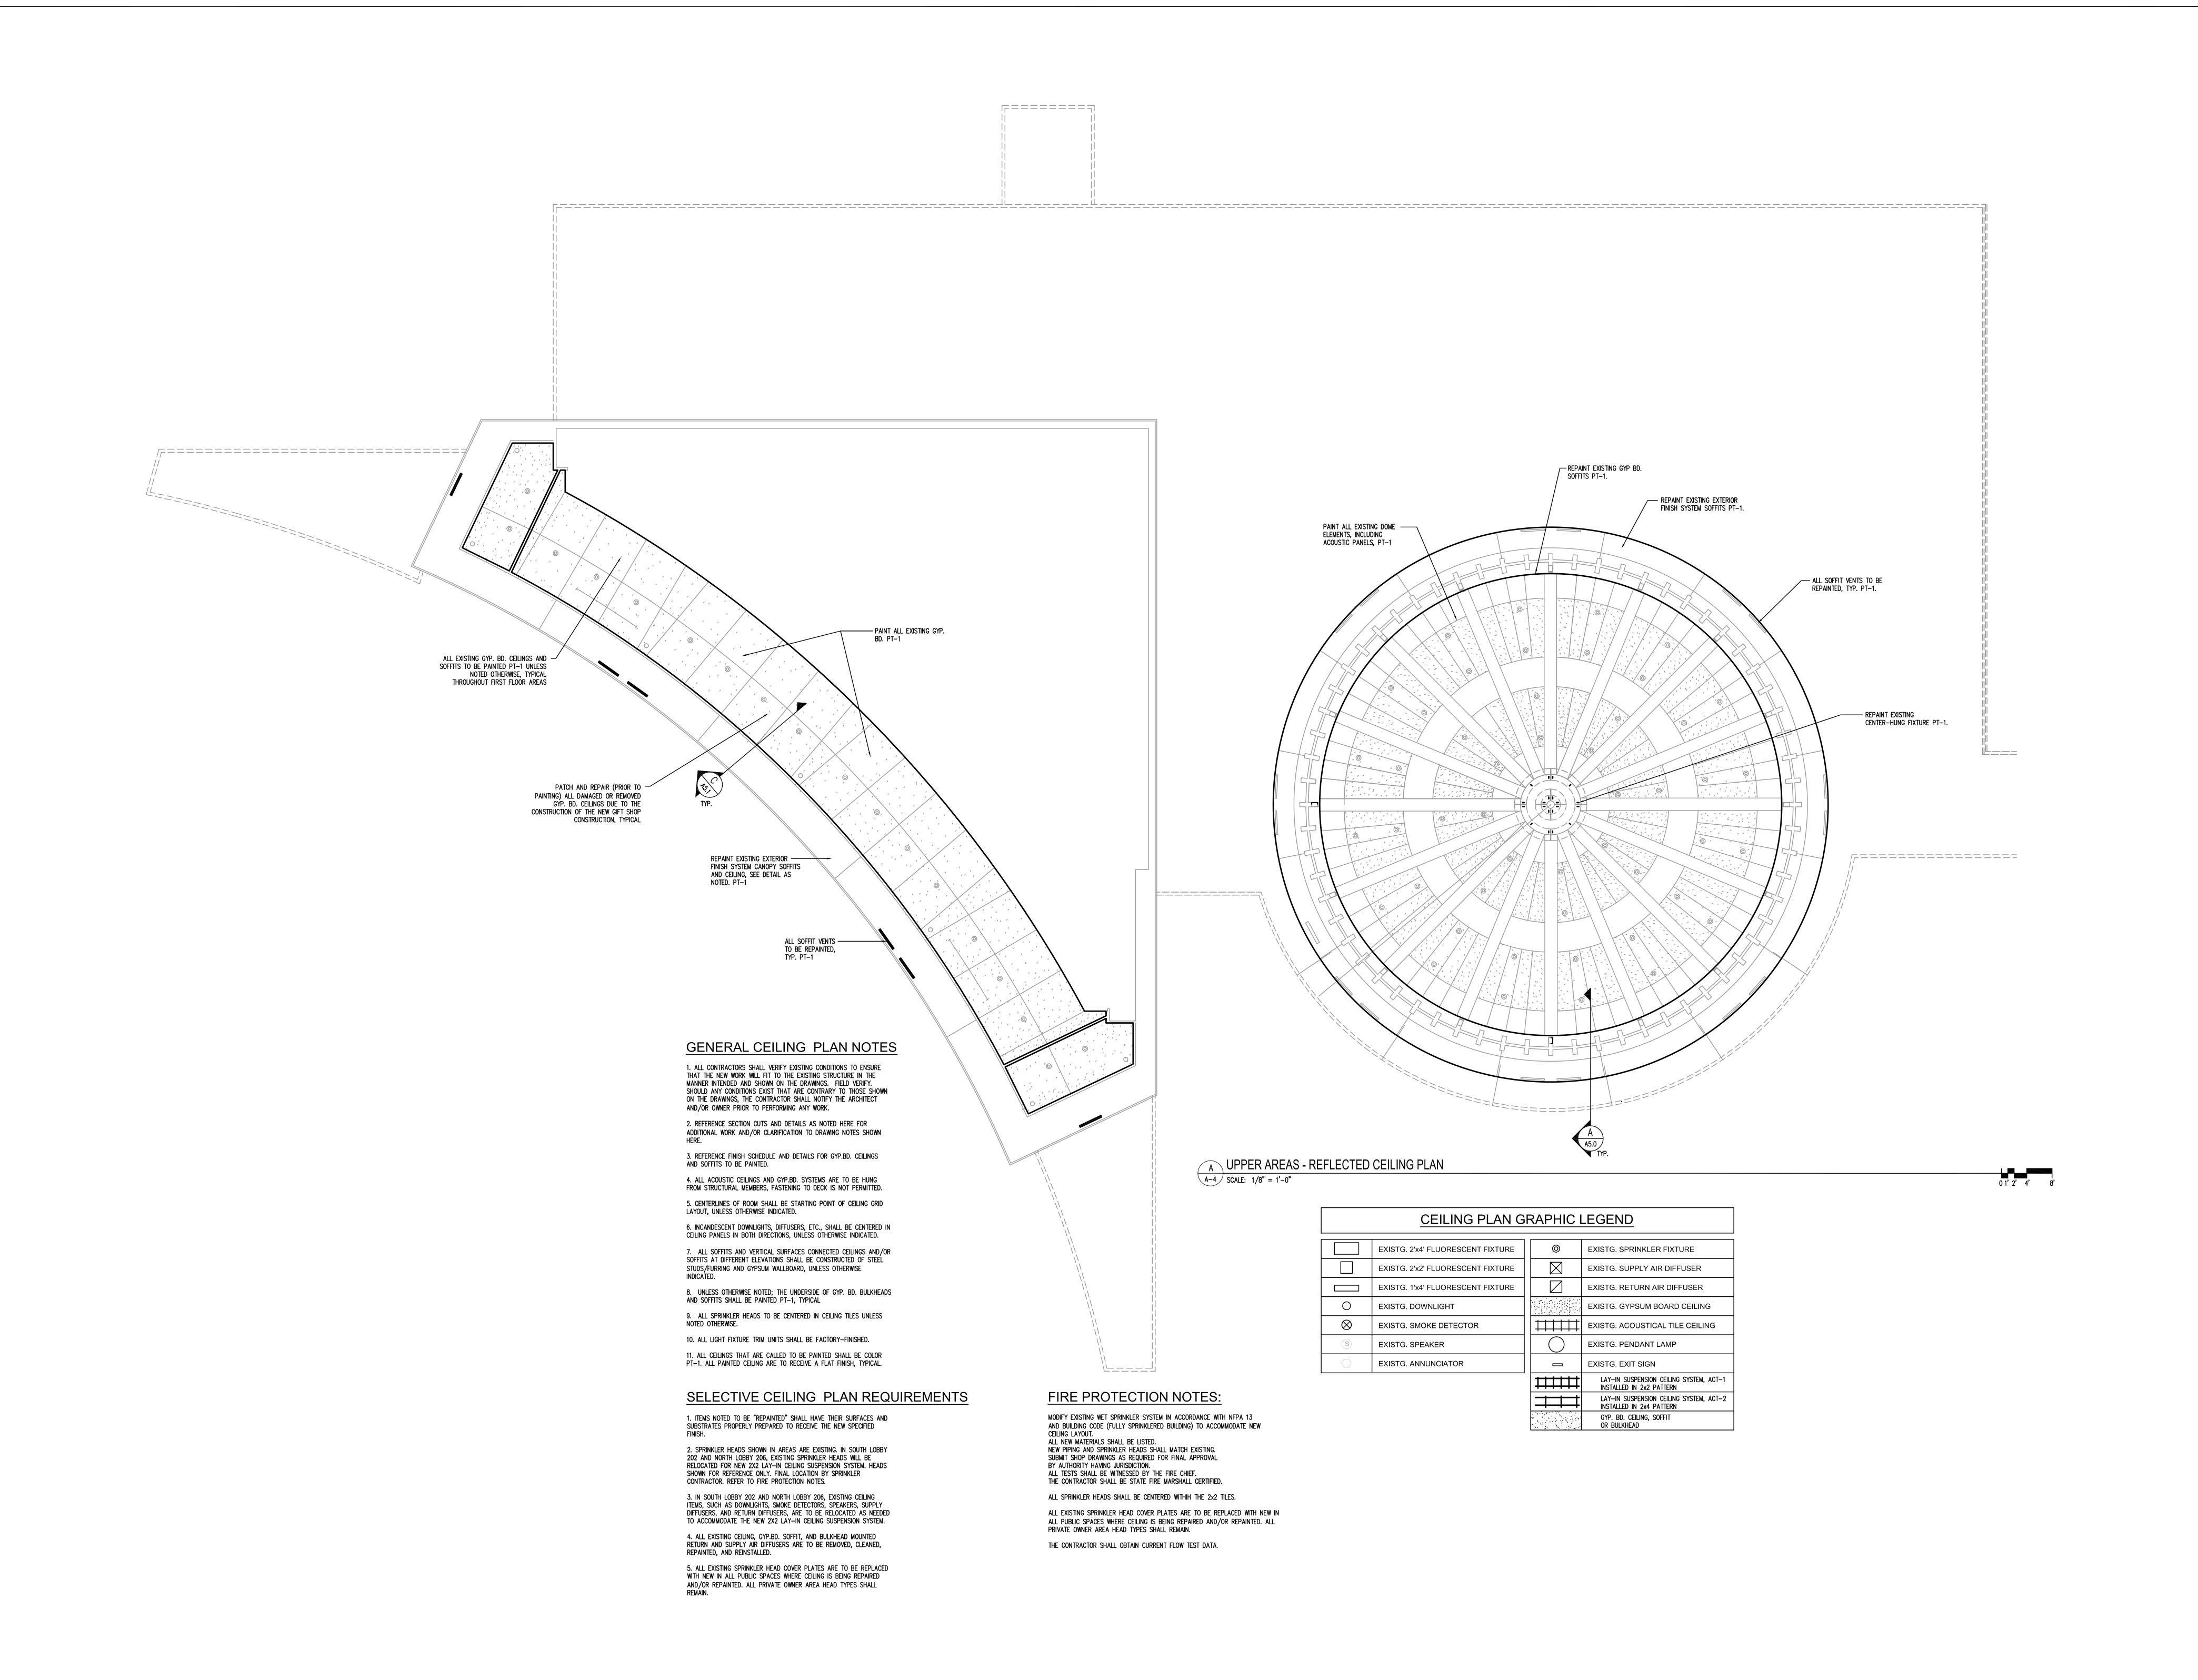

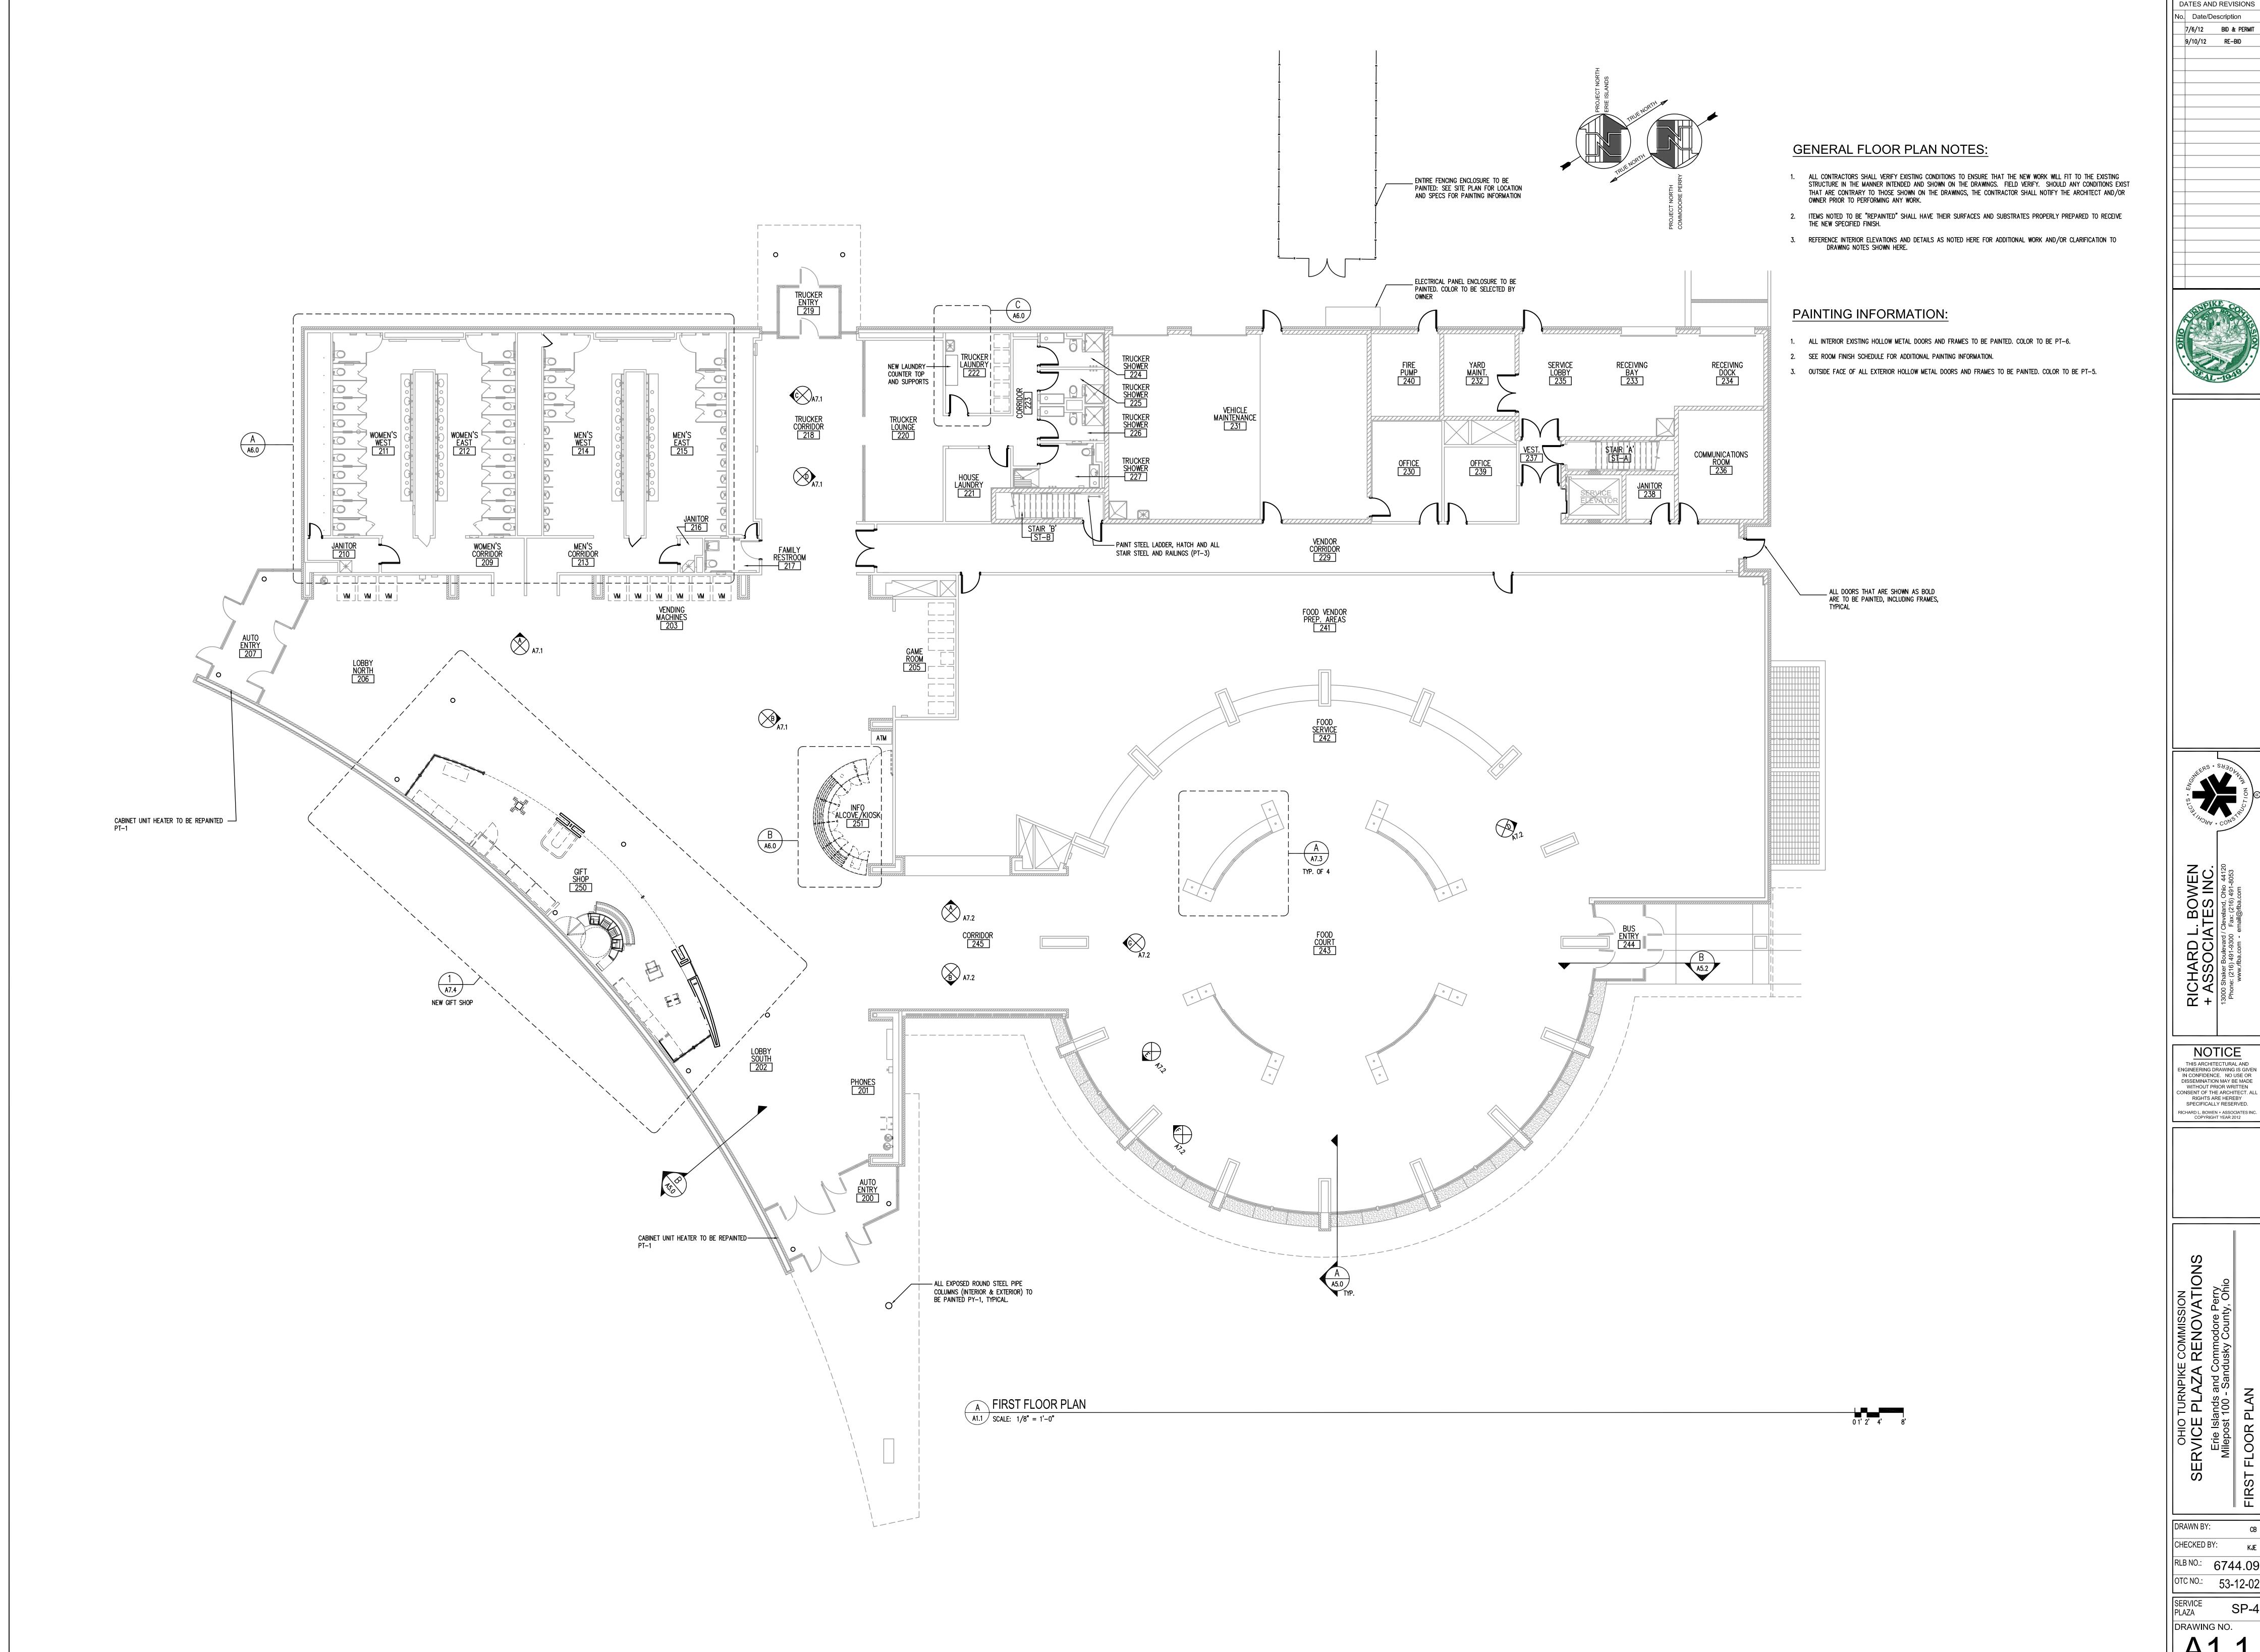
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DRAWN BY: CHECKED BY: | RLB NO.: 6744.09


OTC NO.: 53-12-02


SP-4 DRAWING NO.



7/6/12 BID & PERMIT 9/10/12 RE-BID

No Date/Description

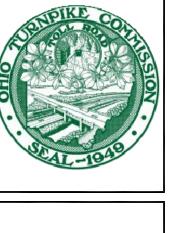

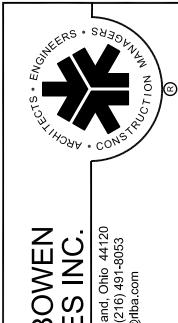



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DRAWN BY:

CHECKED BY: RLB NO.: 6744.09 OTC NO.: 53-12-02

SERVICE PLAZA DRAWING NO.



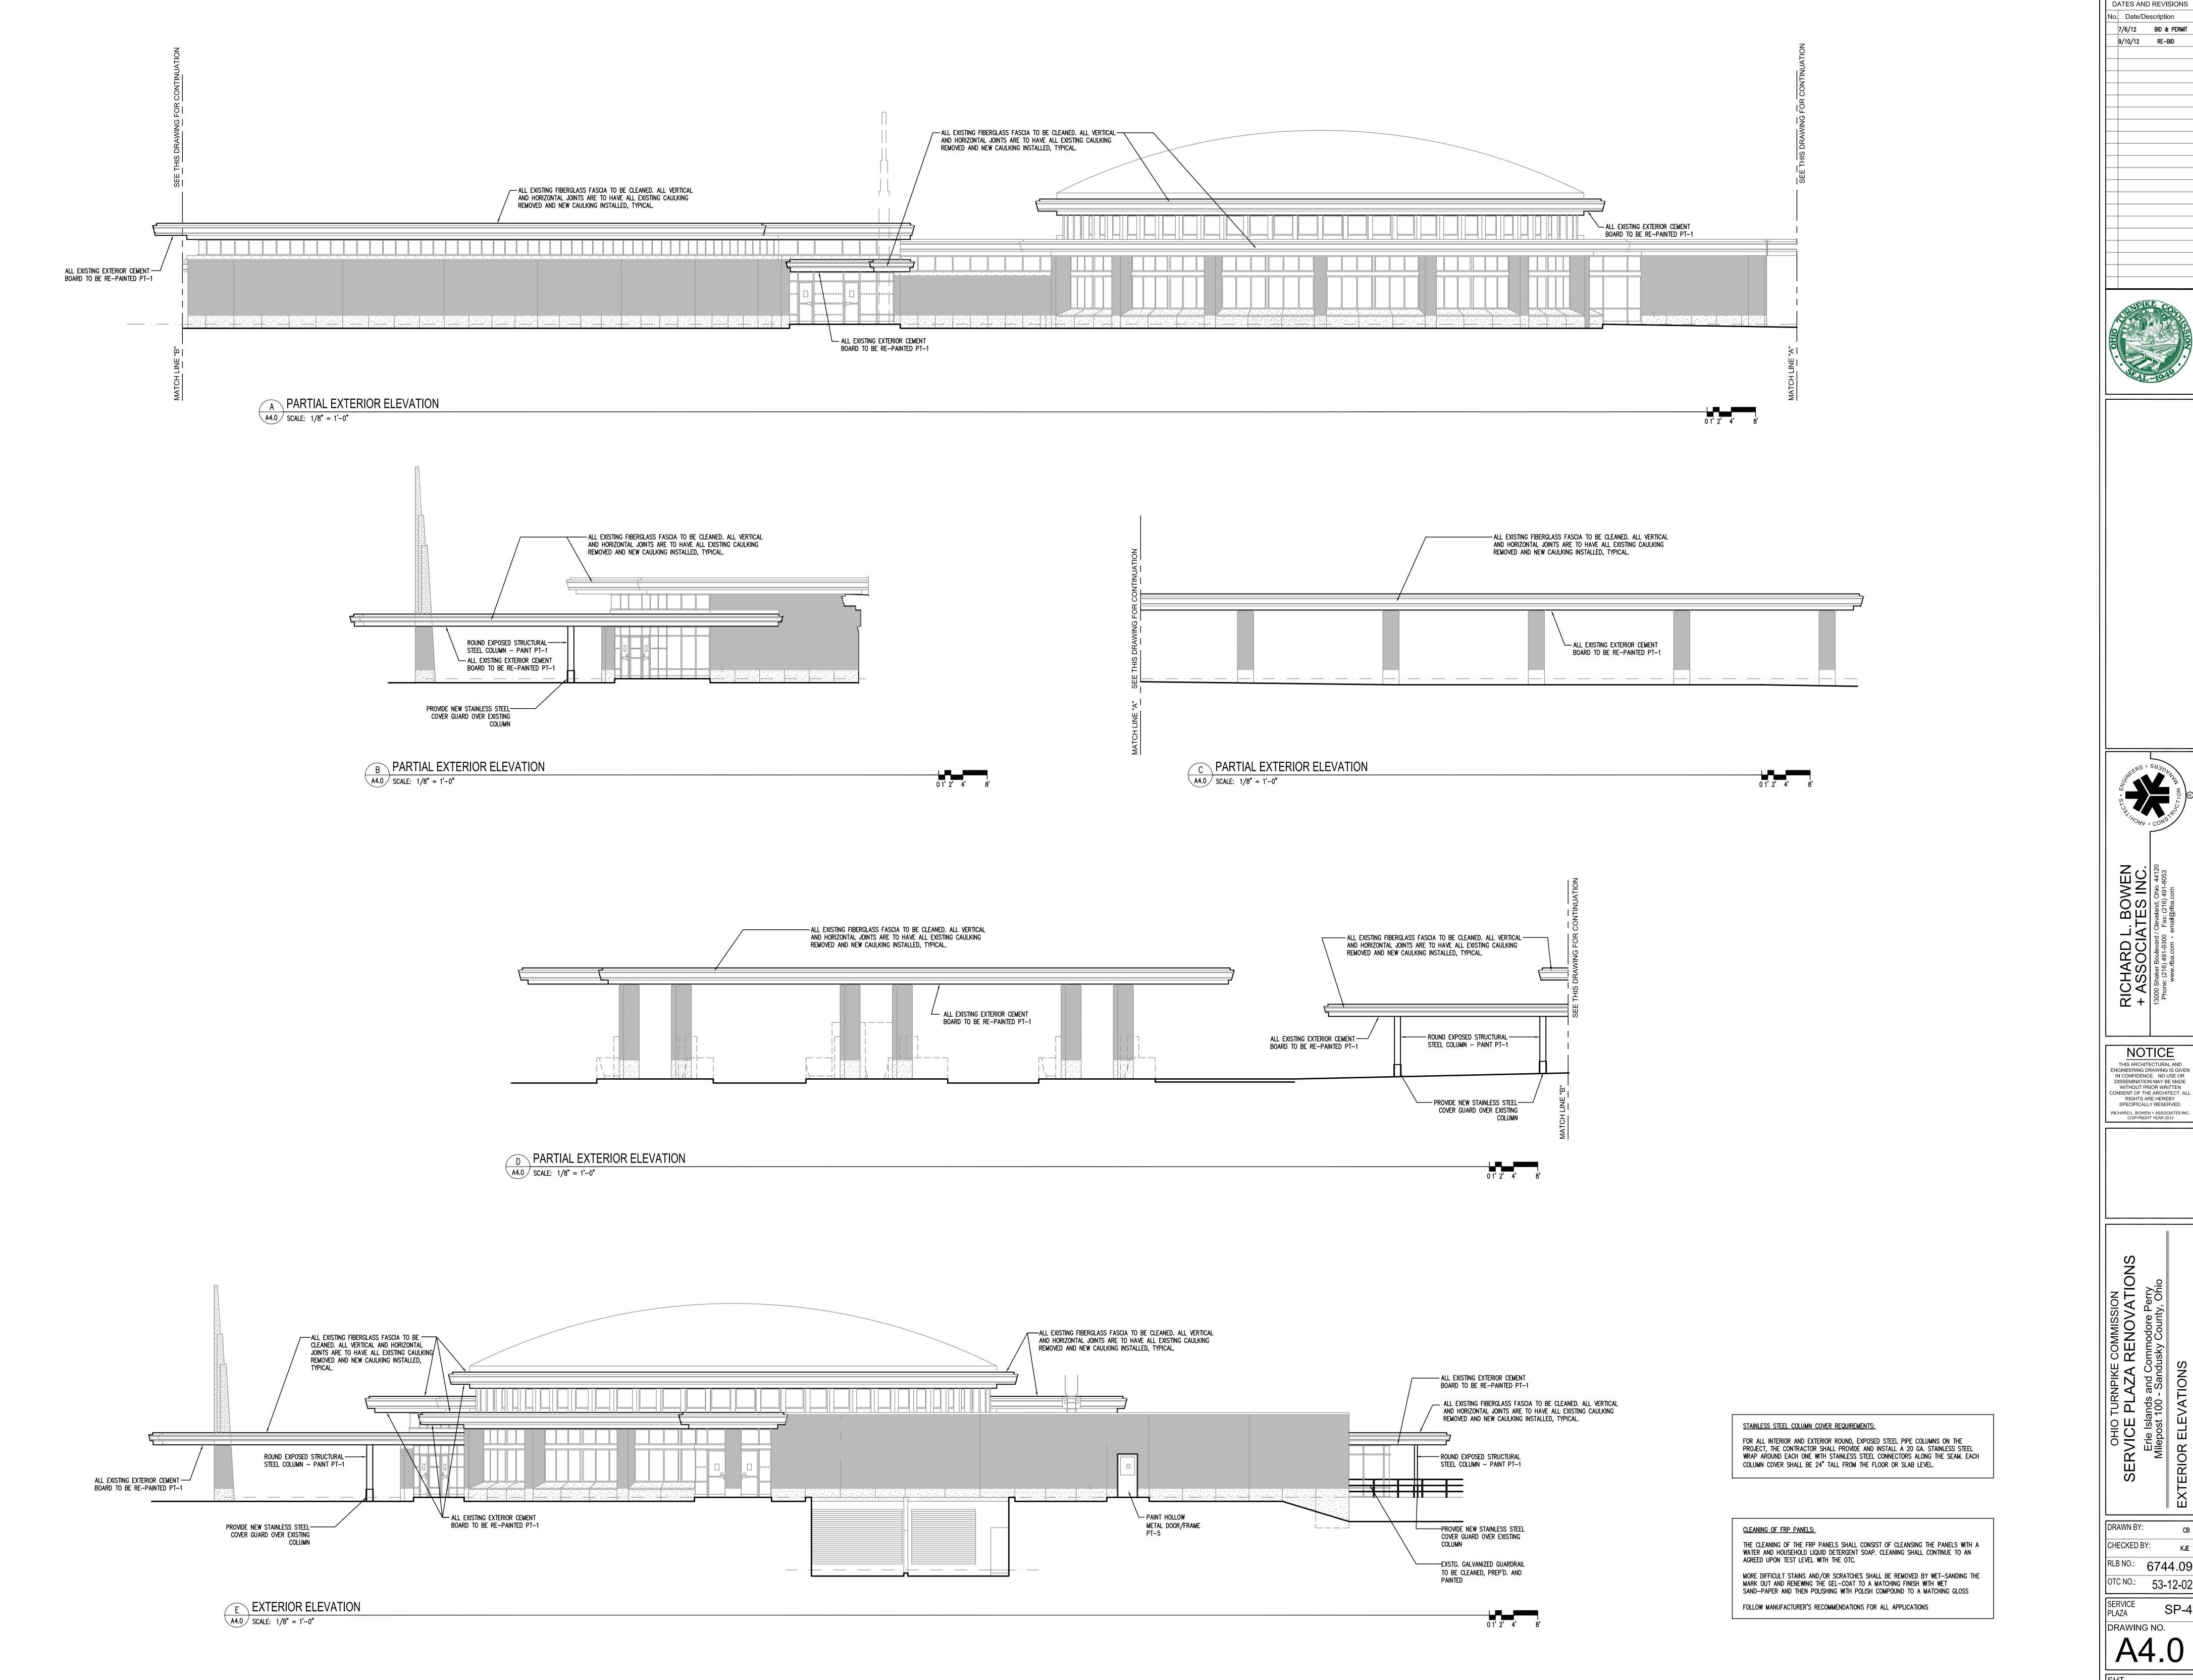


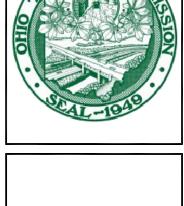

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CHECKED BY: RLB NO.: 6744.09 OTC NO.: 53-12-02 SERVICE




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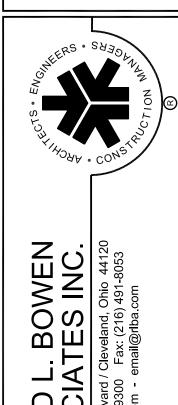
RLB NO.: 6744.09 OTC NO.: 53-12-02 SERVICE SP-4
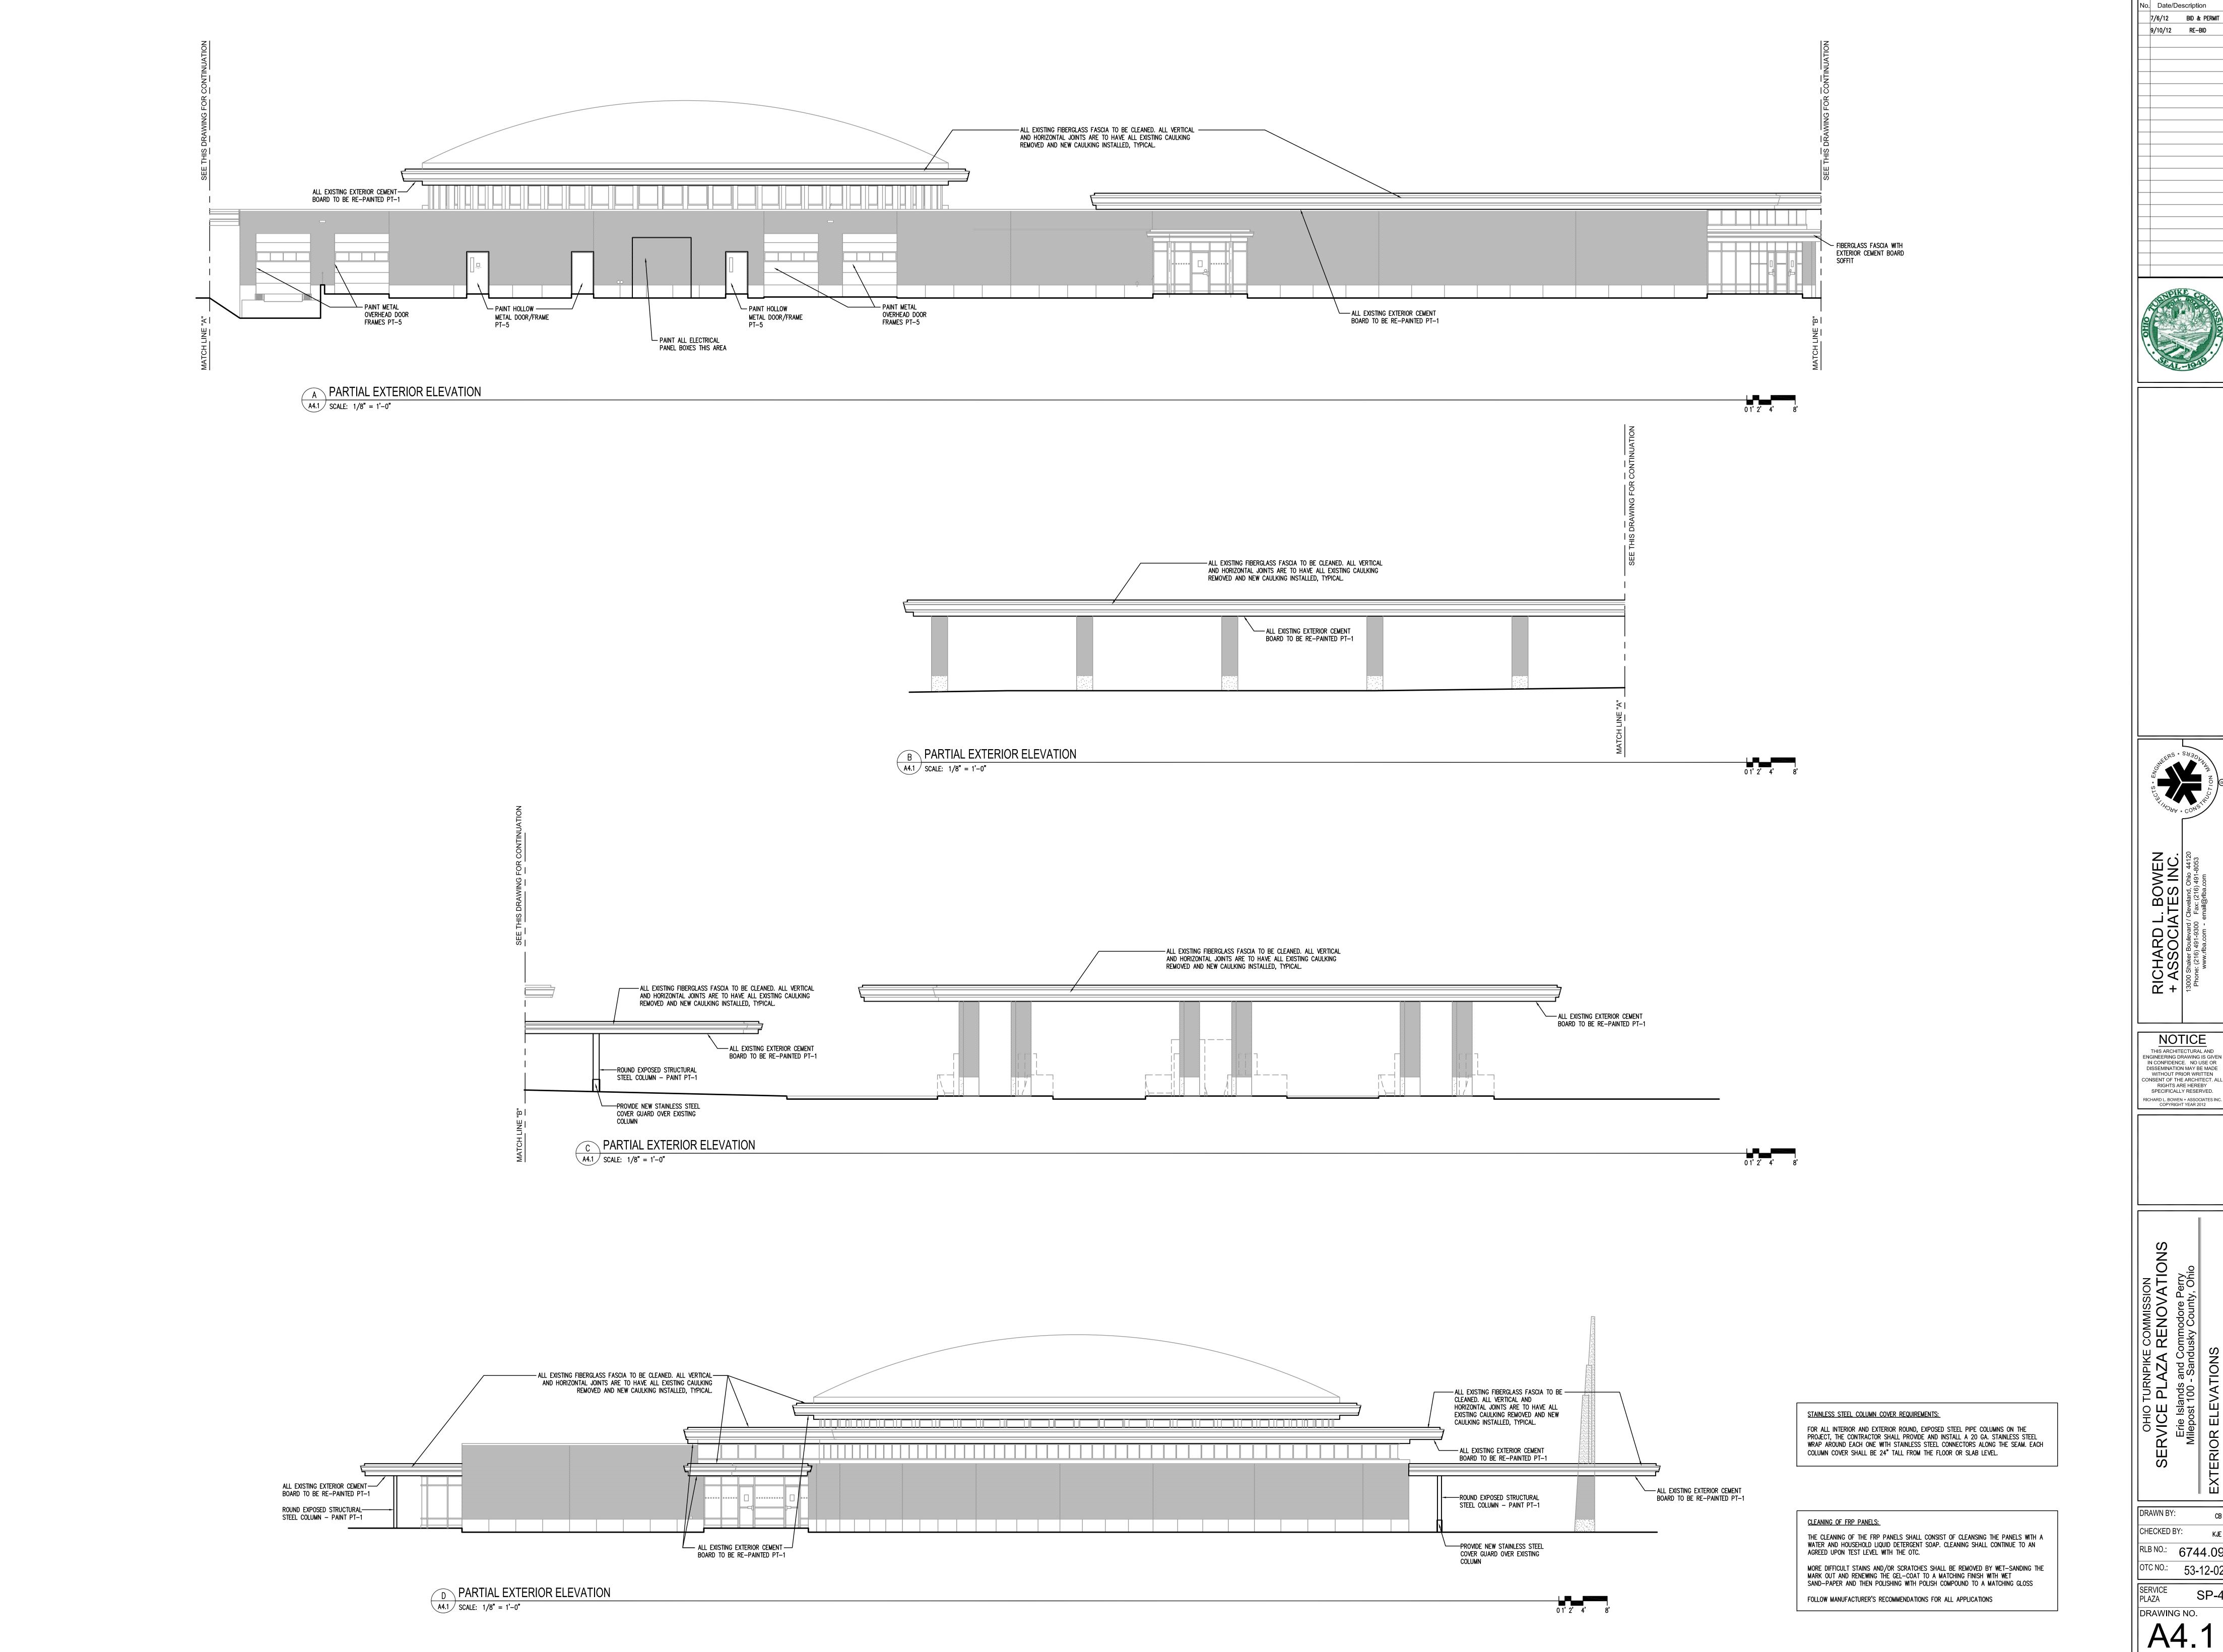
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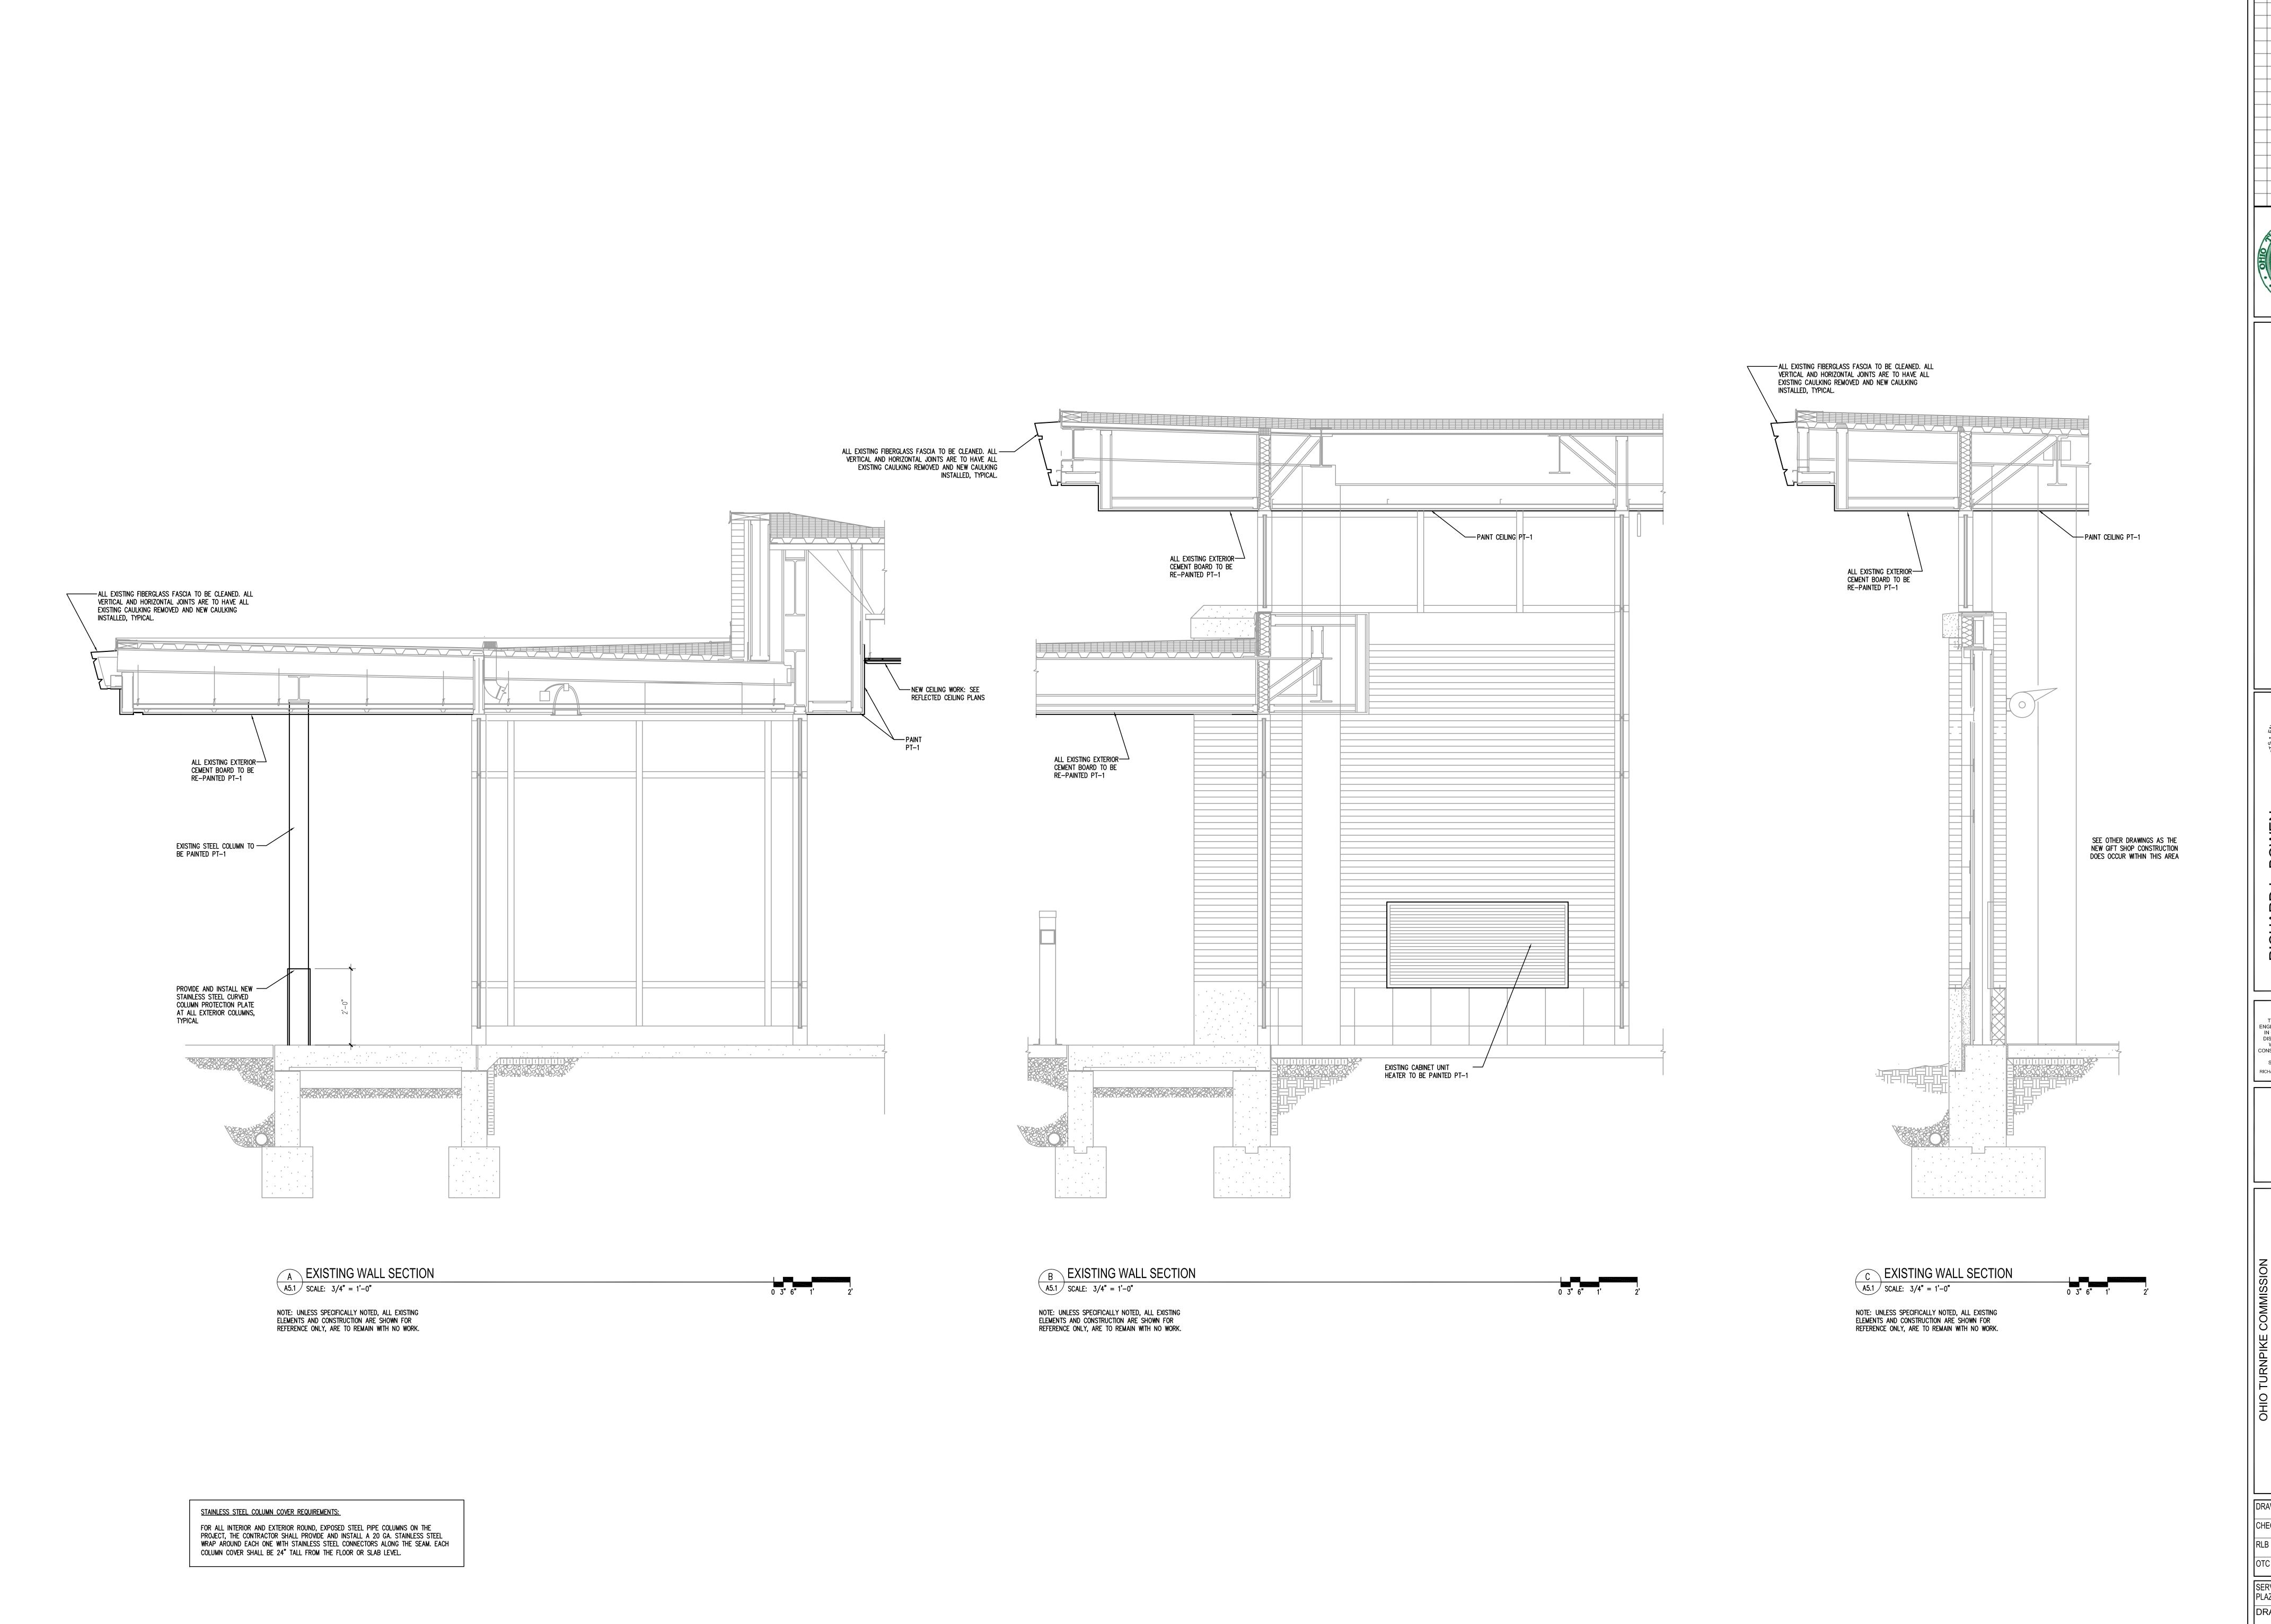
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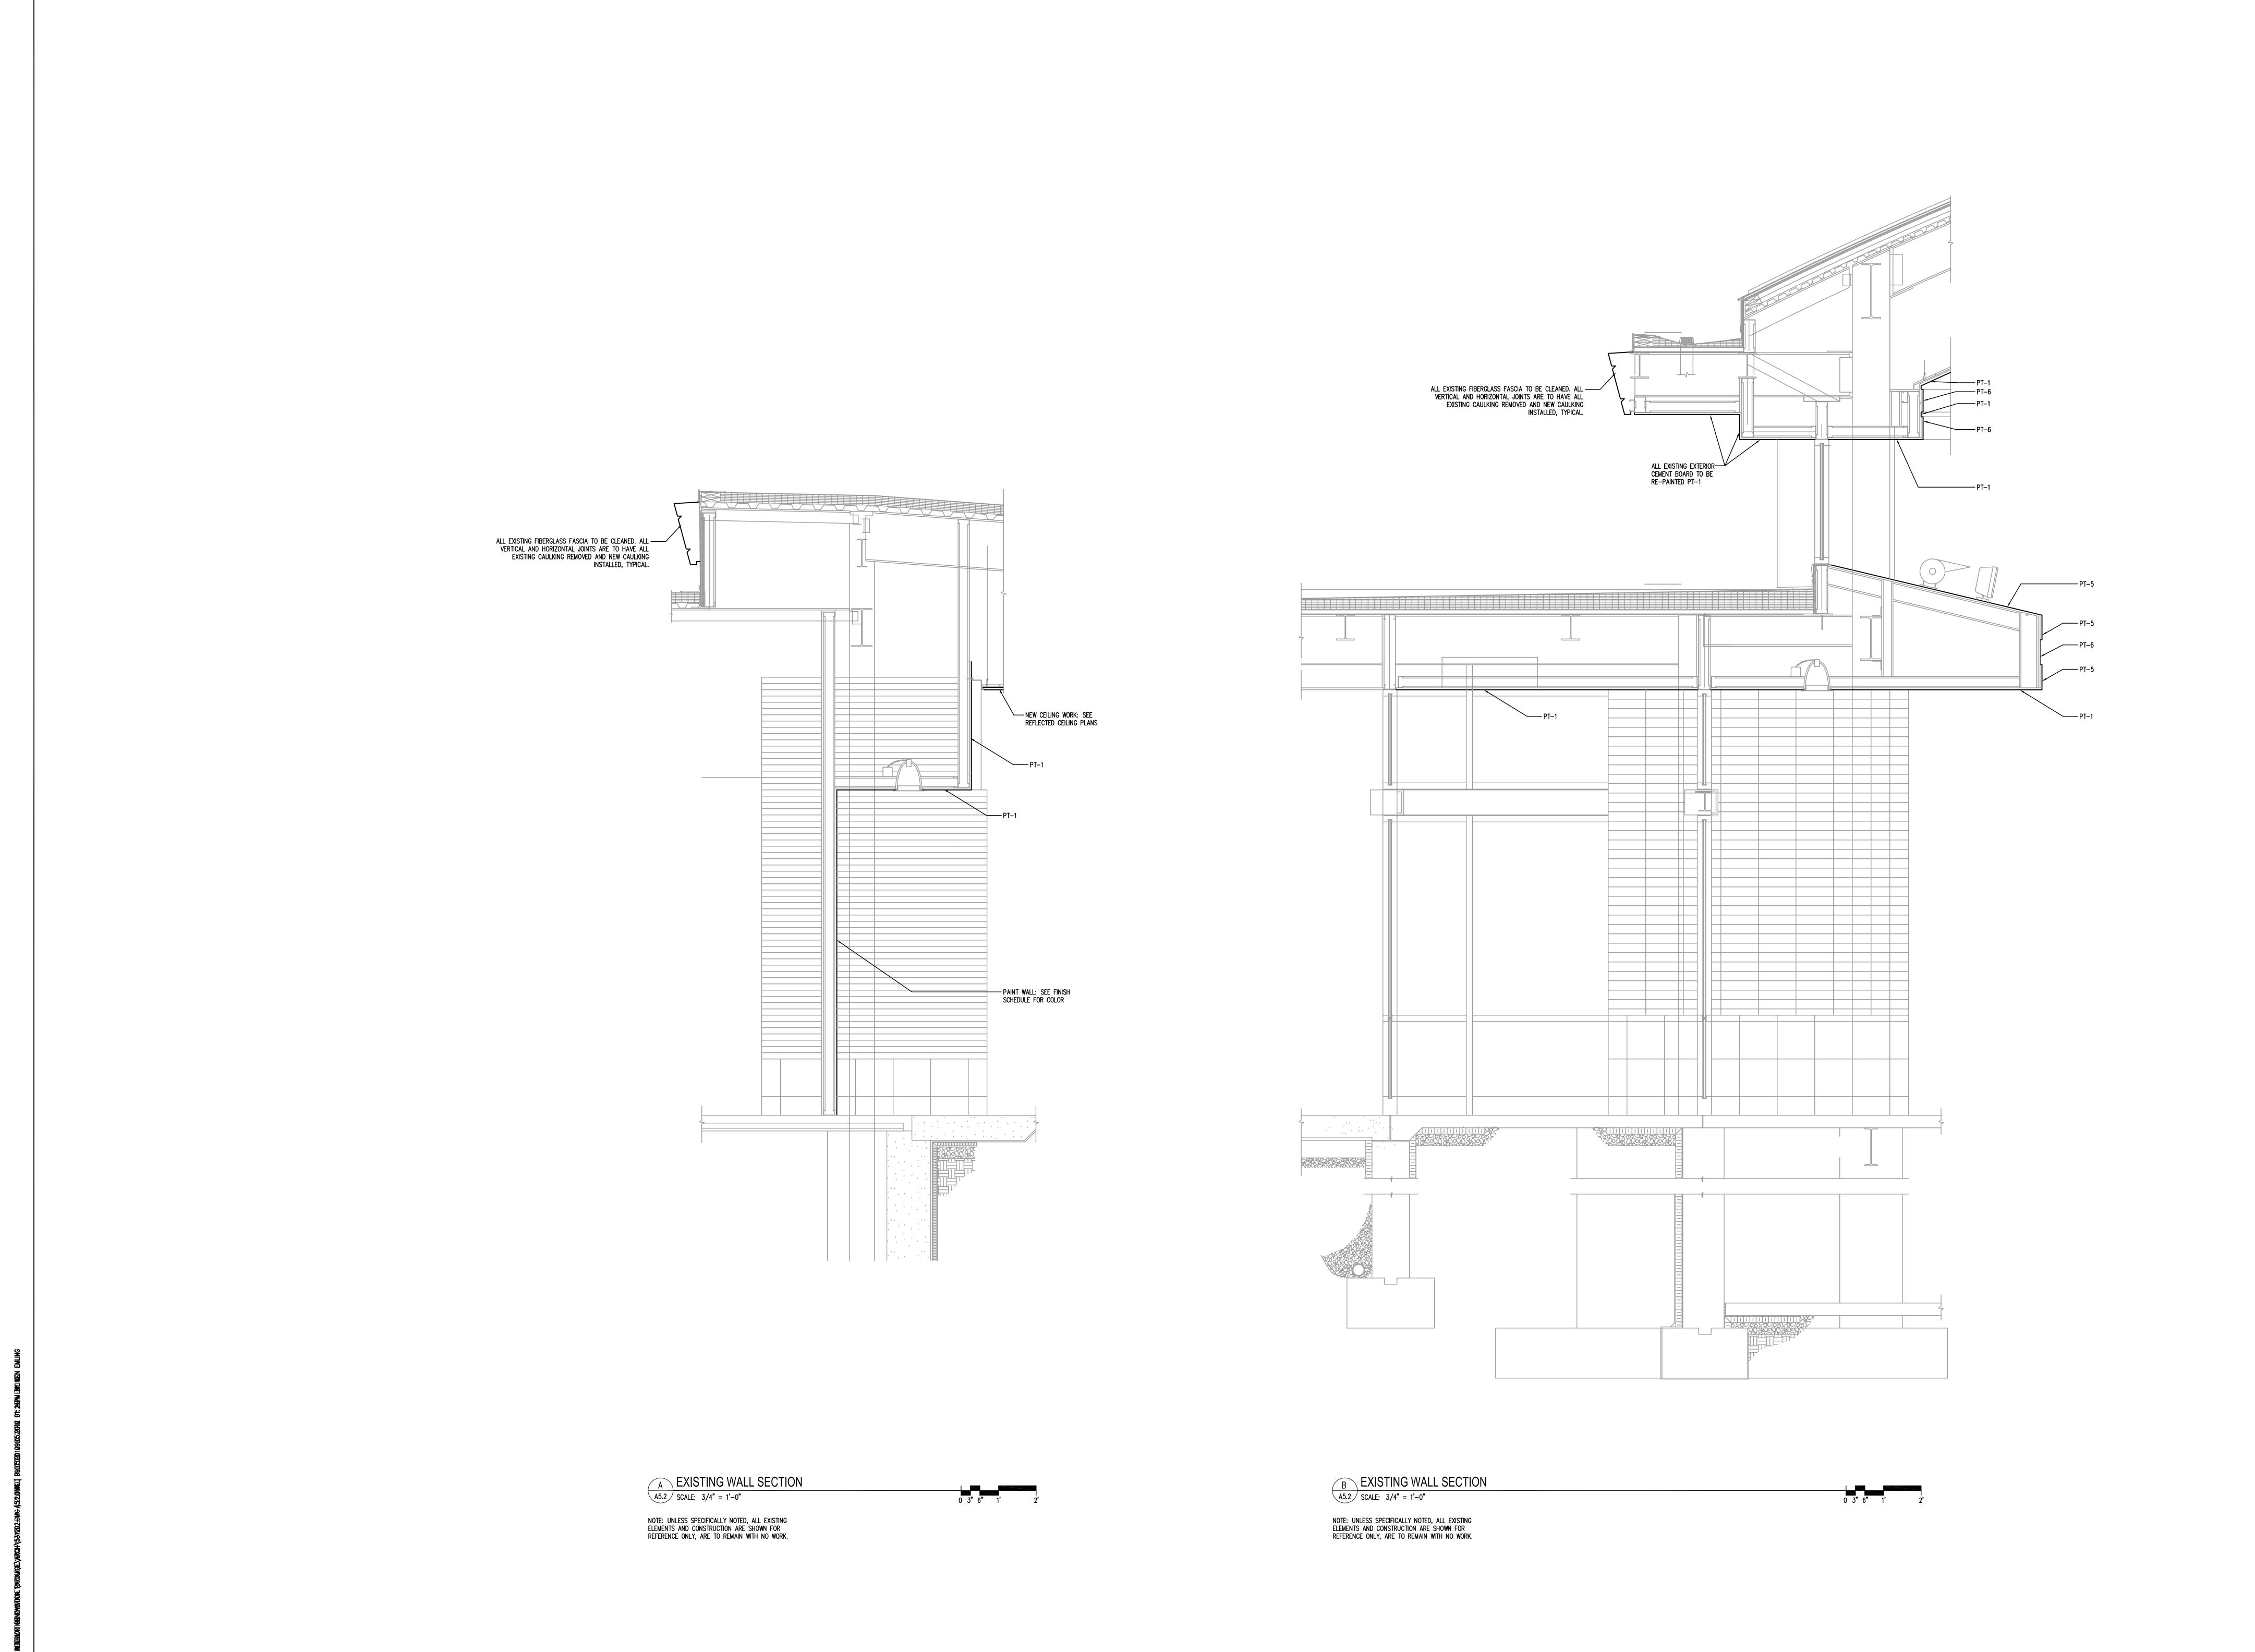
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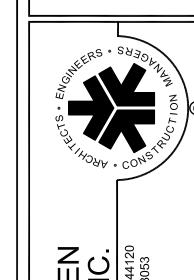
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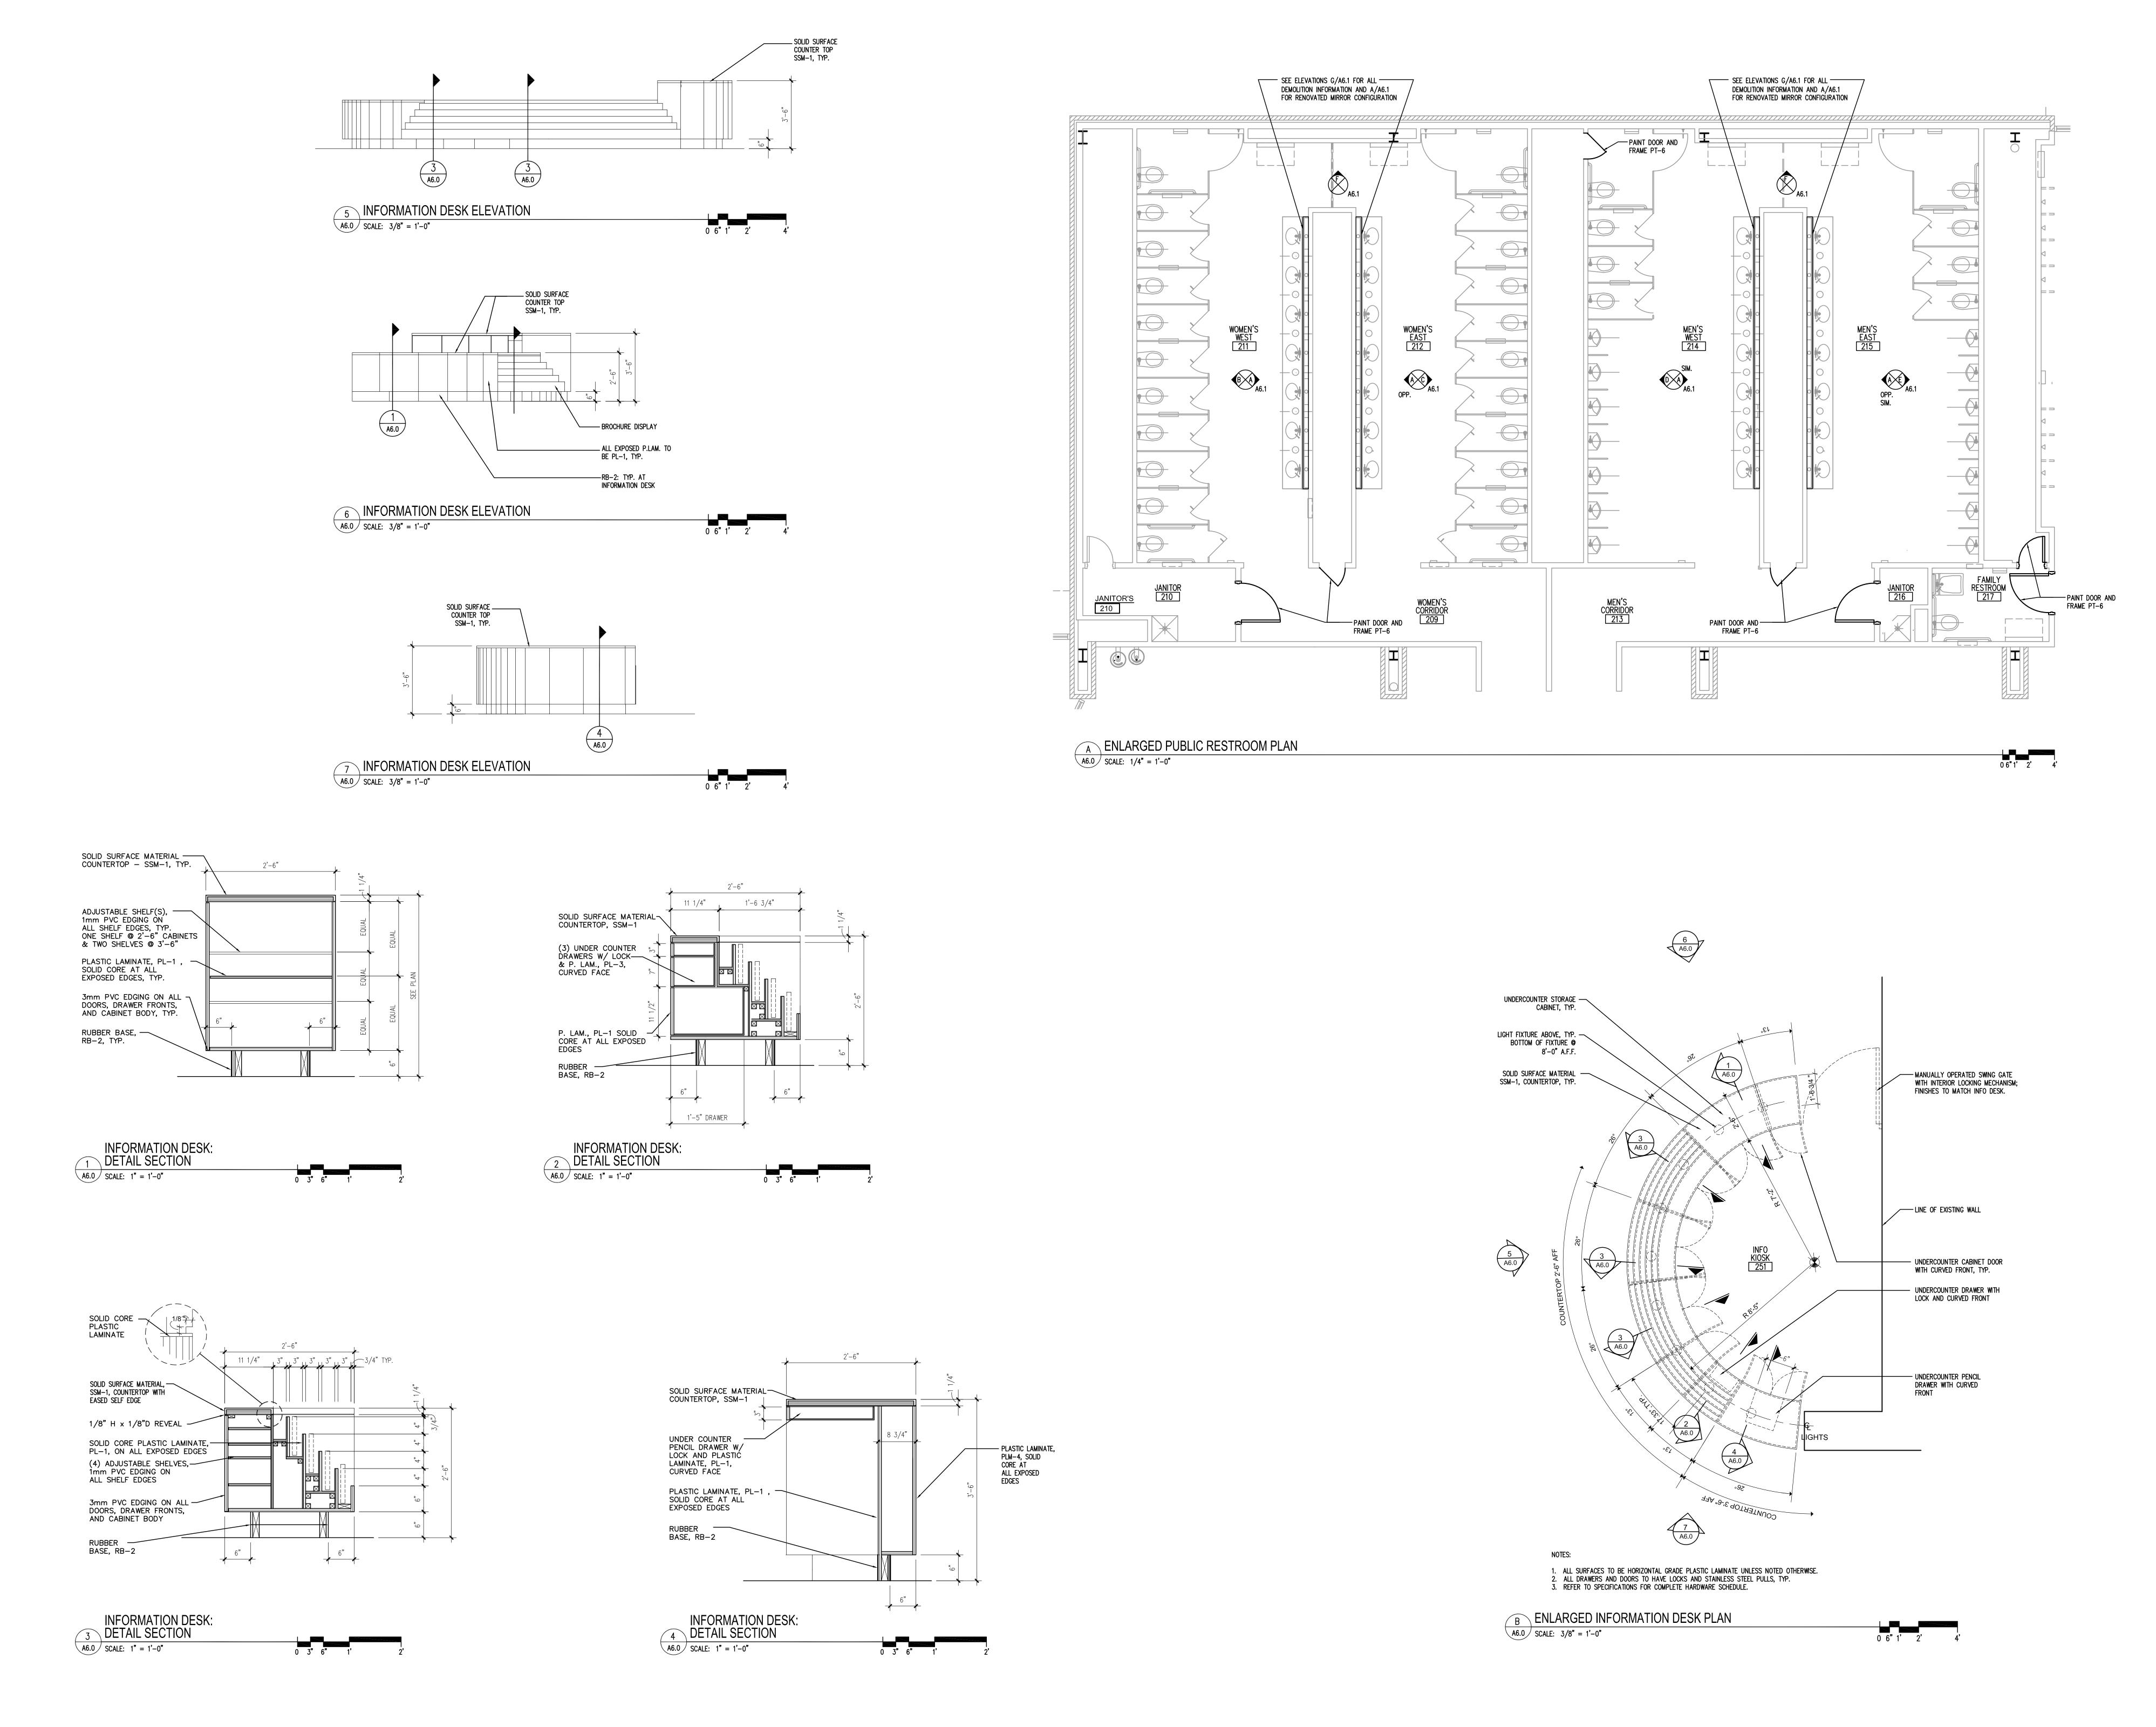
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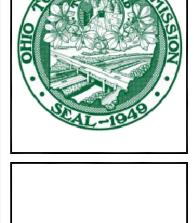



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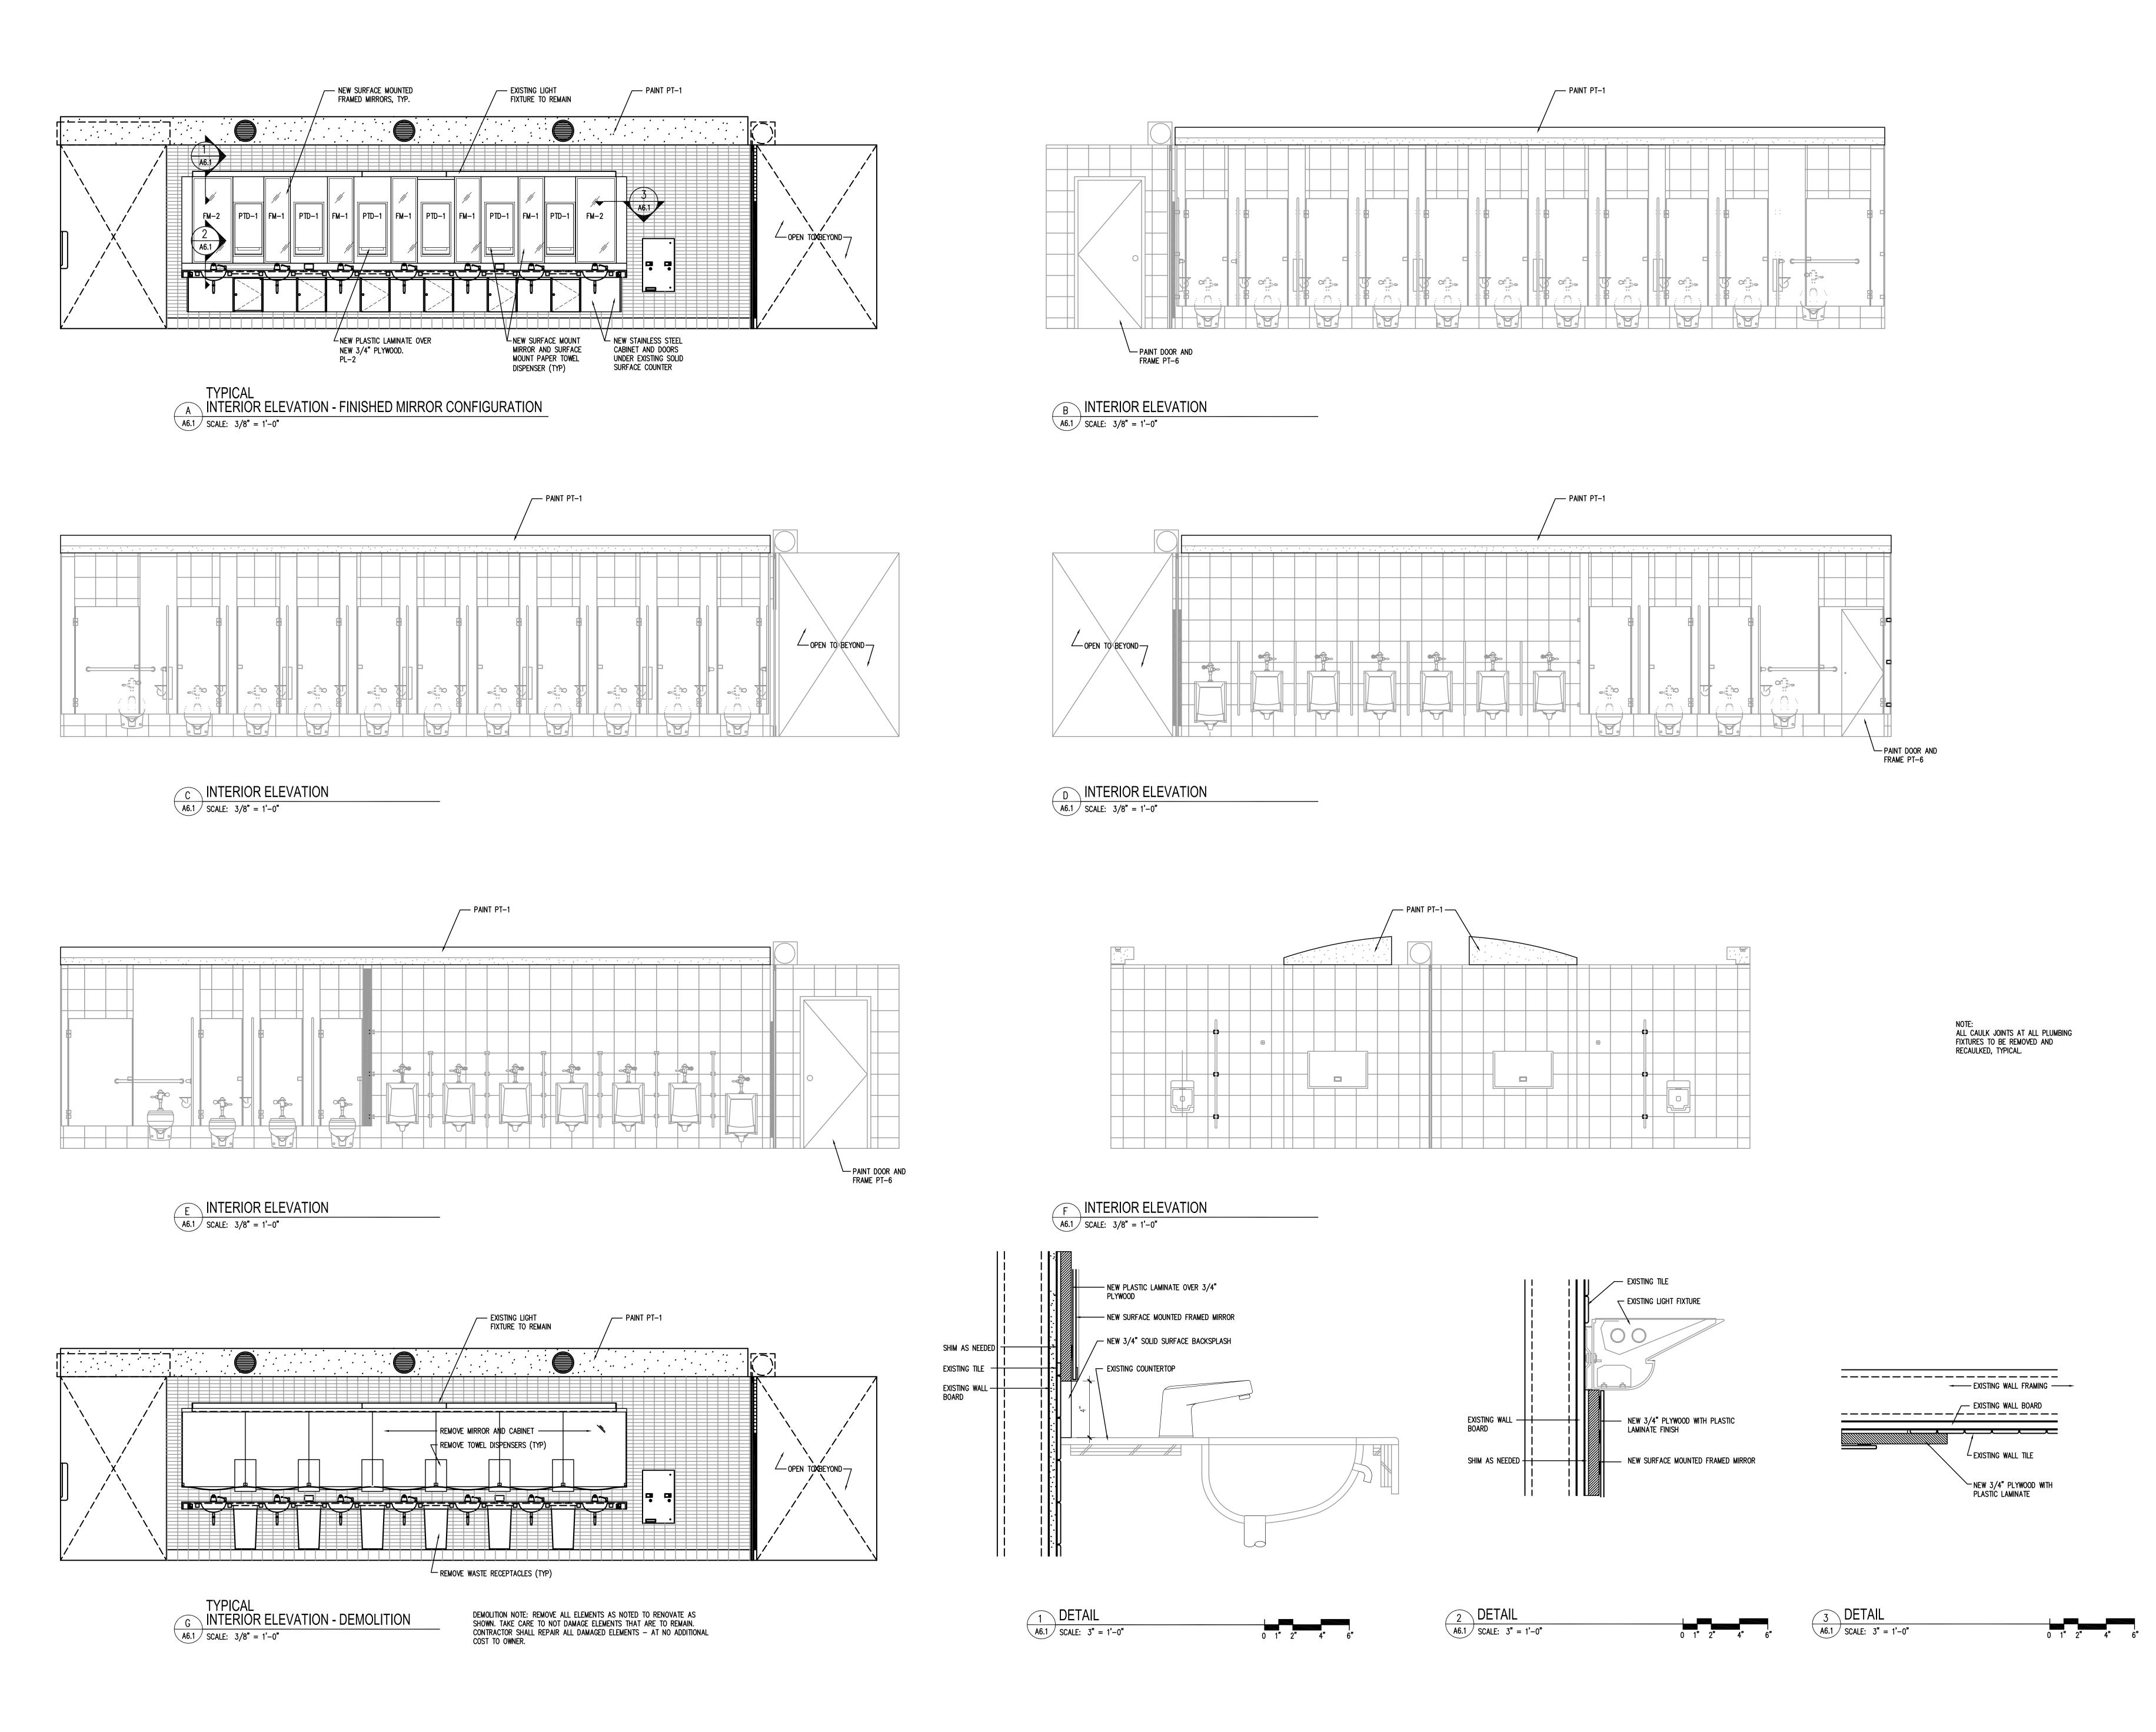




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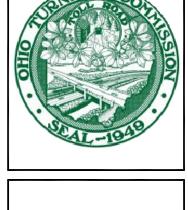


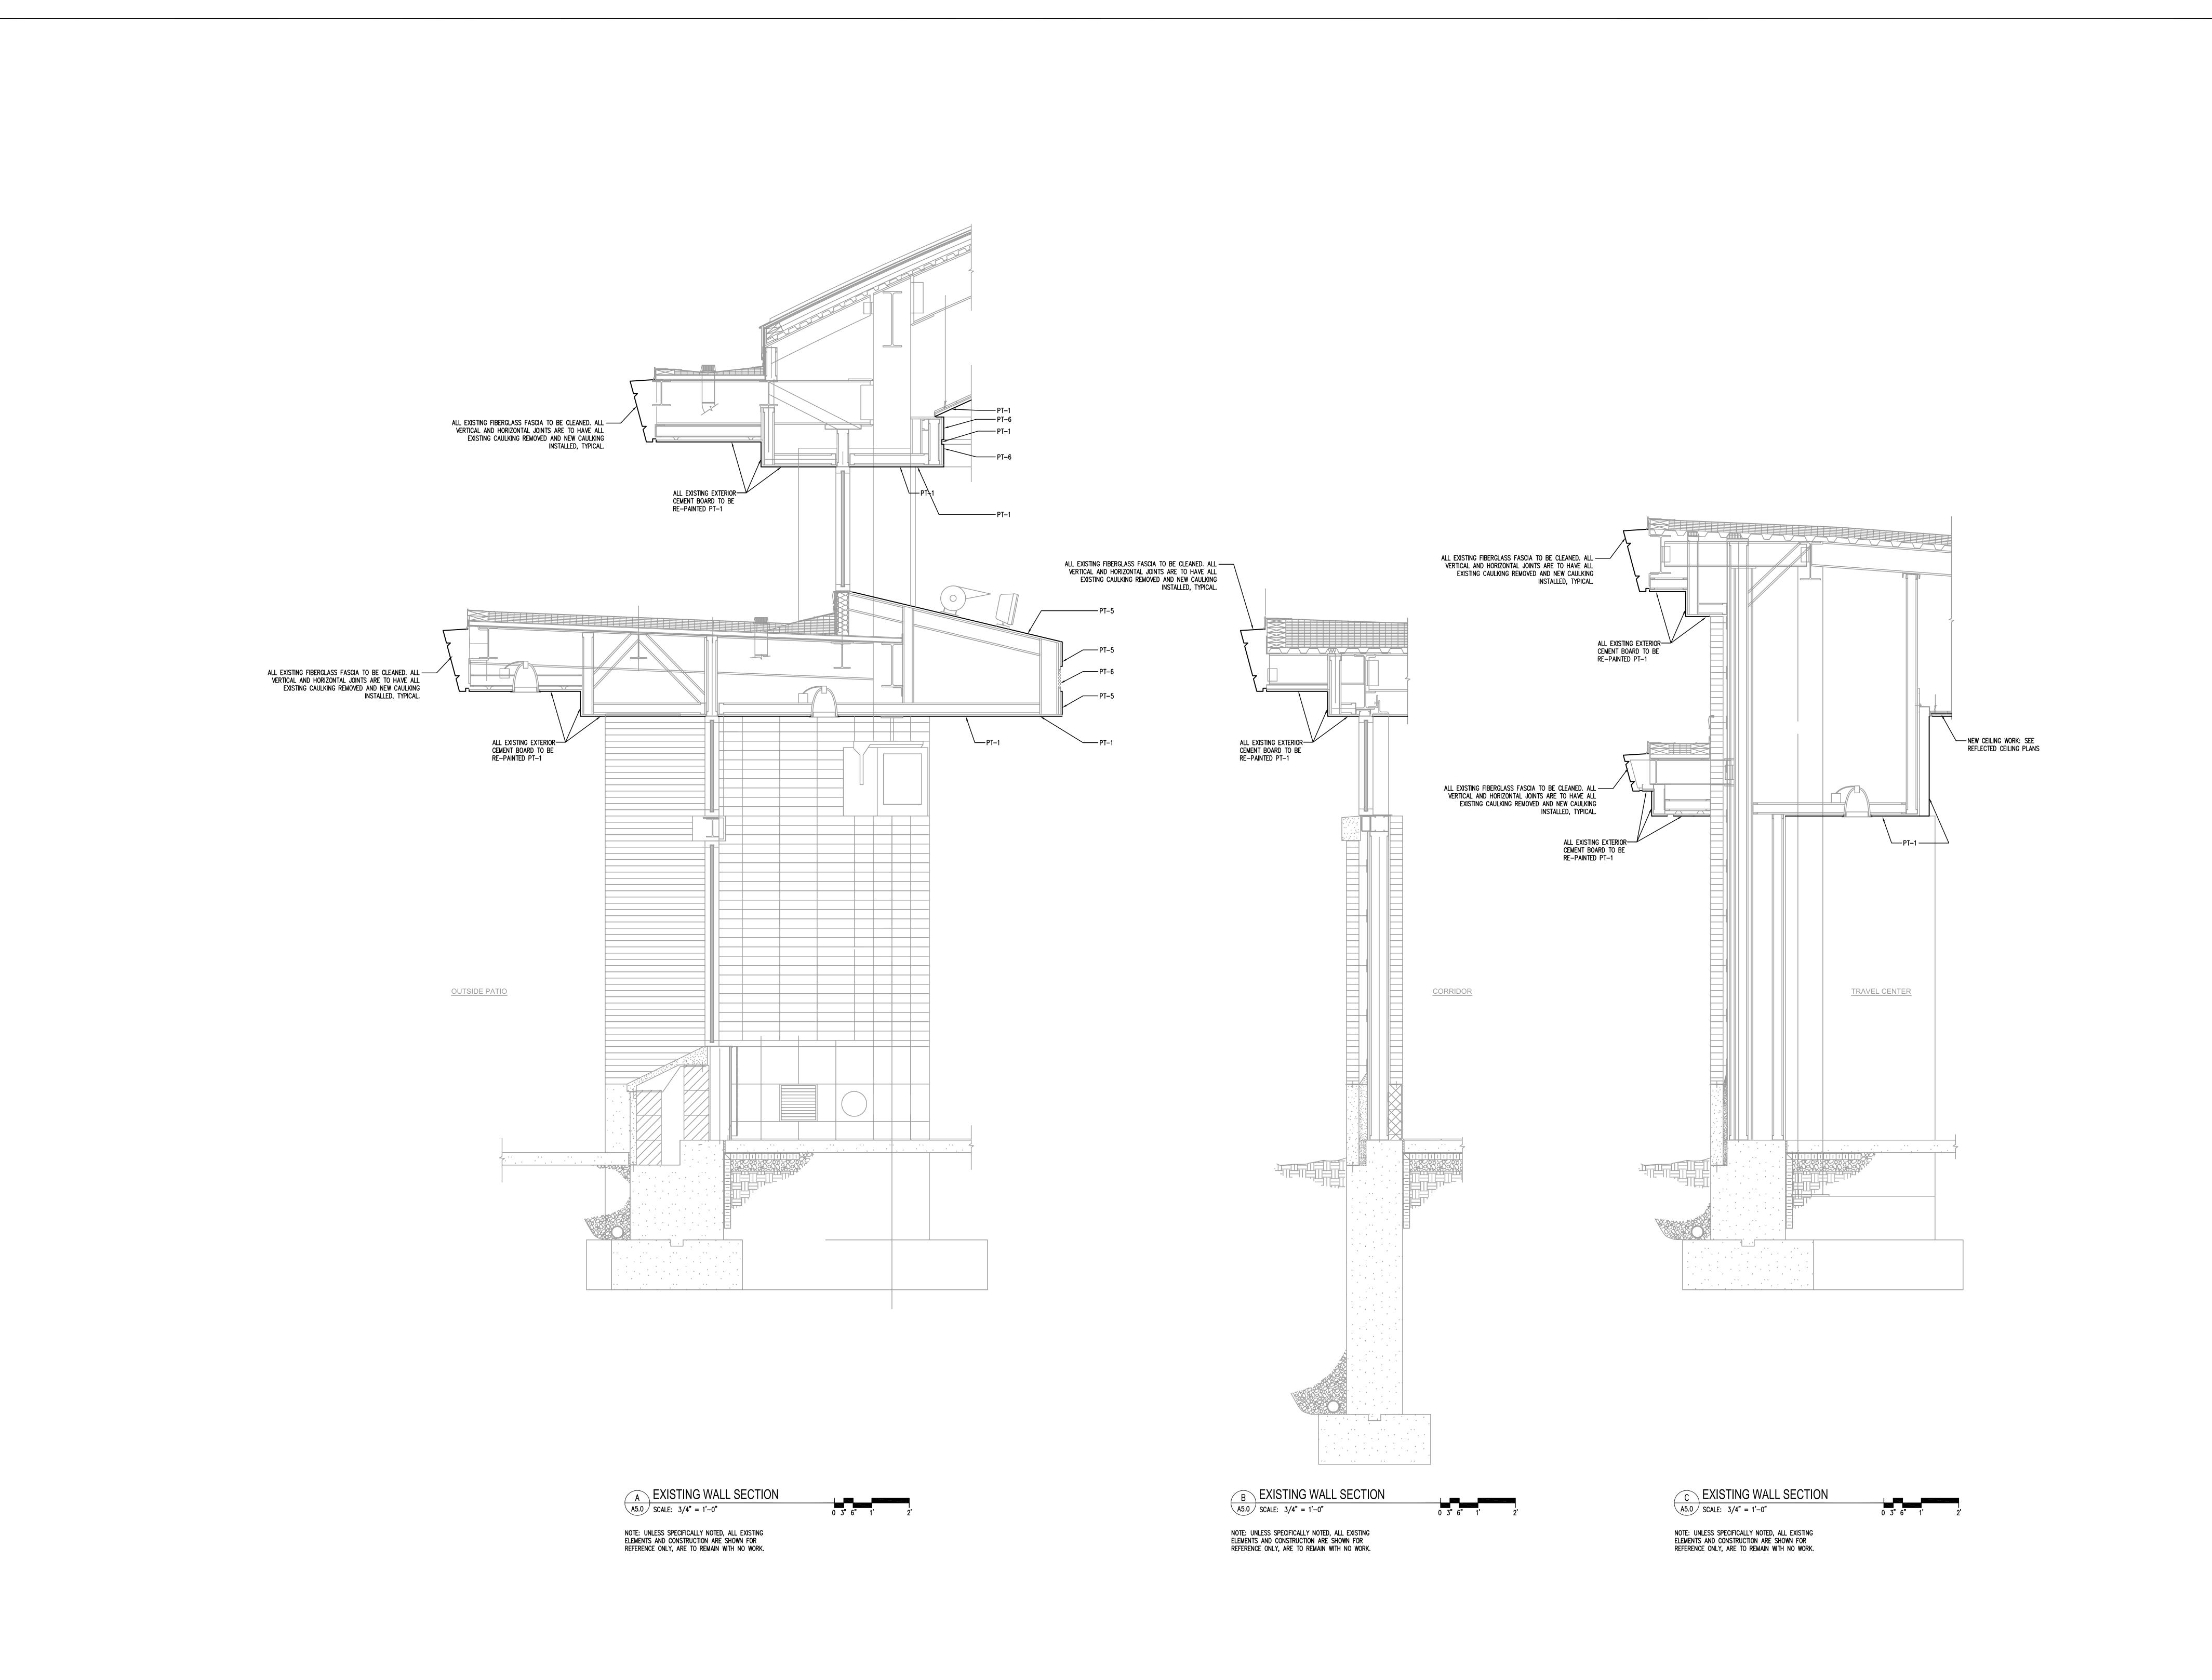
9/10/12 RE-BID

DATES AND REVISIONS

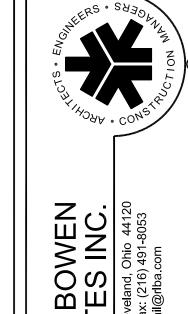7/6/12 BID & PERMIT

No. Date/Description



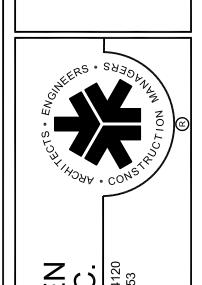

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OTC NO.: 53-12-02 SERVICE PLAZA

FIRST FLOOR FINISH PLAN A7.0 SCALE: 1/8" = 1'-0" NOTE: EXISTING TO REMAIN UNLESS NOTED OTHERWISE NOTE:
CONTRACTOR SHALL INCLUDE THE REMOVAL AND REPLACEMENT
OF FIFTY (50) DAMAGED TILES PER SIDE. ACTUAL TILES TO BE
DETERMINED IN FIELD WITH OWNER. THE OWNER WILL PROVIDE
THE TILES, THE CONTRACTOR SHALL SUPPLY ALL OTHER
MATERIALS TO PROVIDE A COMPLETE INSTALLATION.

DRAWN BY:

DRAWING NO.

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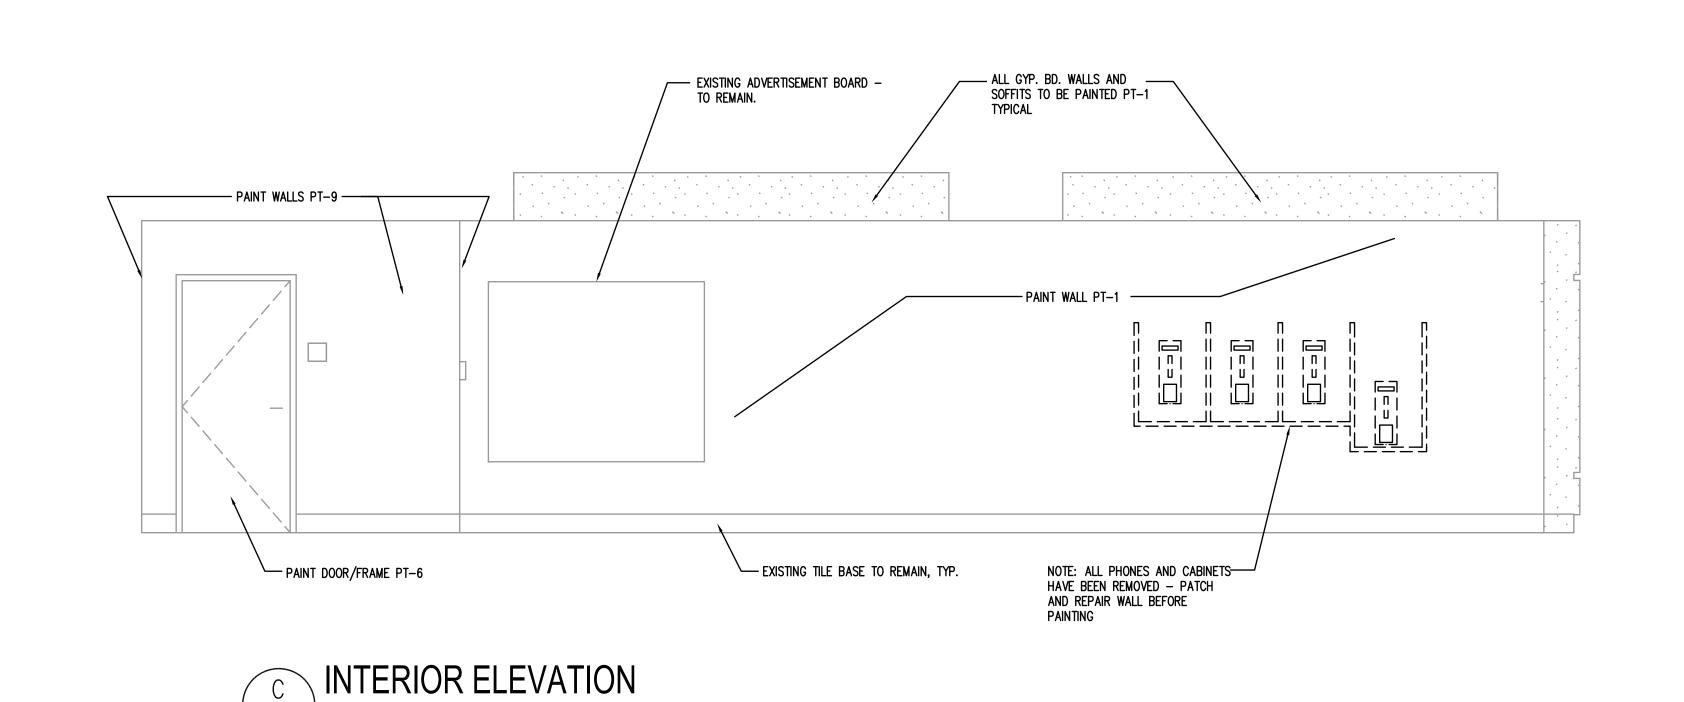
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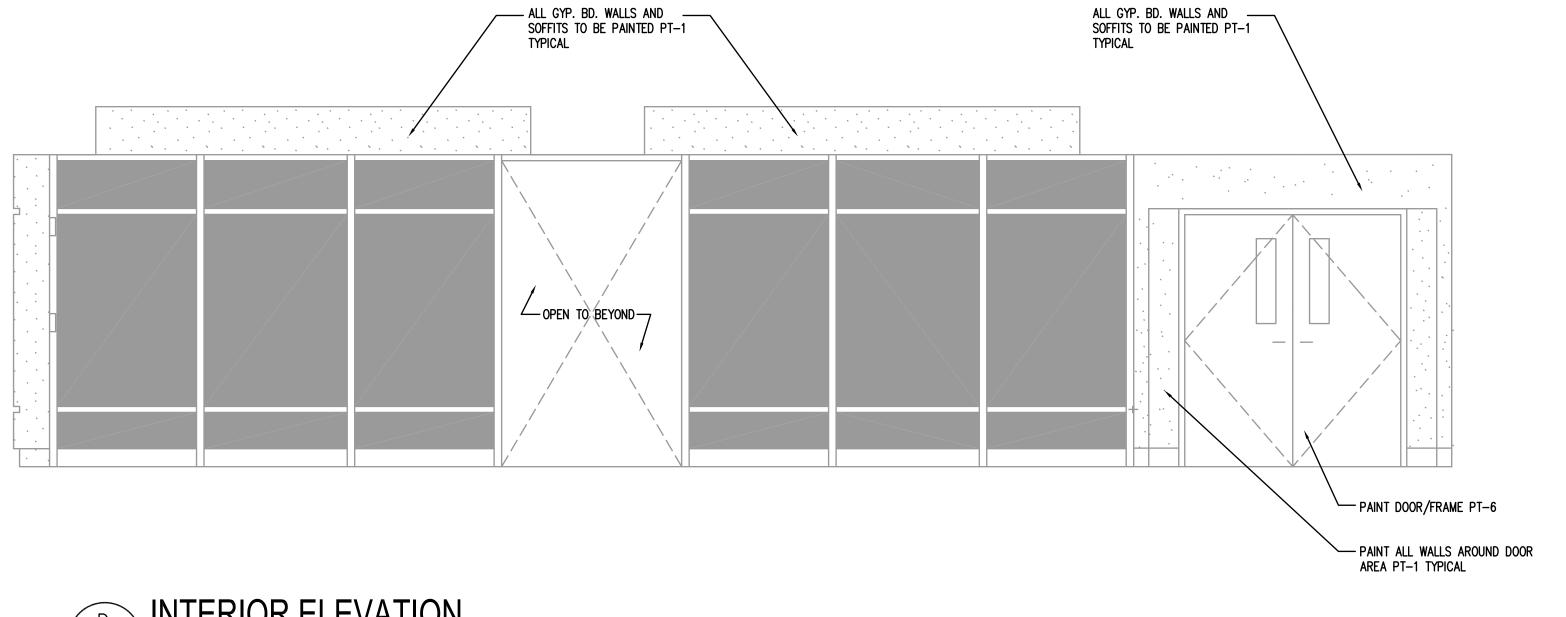
ALL GYP. BD. WALLS AND SOFFITS TO BE PAINTED PT-1 TYPICAL ALL GYP. BD. WALLS AND SOFFITS TO BE PAINTED PT-1 TYPICAL — NEW SIGNAGE, TYPICAL. SEE DRAWINGS A8.0 AND A8.1 ALL DIFFUSERS TO BE REMOVED, CLEANED, PAINTED PT-1 AND REINSTALLED, TYPICAL. ATM/Information === Phone Game Room Court Food PAINT (3) WALLS ATM MACHINE OPEN TO BEYOND r-----EXISTING MAP BOARD TO REMAIN NOTE TWO (2) PHONES AND
CABINETS HAVE BEEN REMOVED —
PATCH AND REPAIR WALL PRIOR EXISTING TILE BASE TO REMAIN, TYP.

LINE OF NEW INFORMATION KIOSK

B INTERIOR ELEVATION A7.1 SCALE: 13/8" = 1'-0"

A7.1 SCALE: 3/8" = 1'-0"





— ALL GYP. BD. WALLS AND

D INTERIOR ELEVATION A7.1 SCALE: 3/8" = 1'-0"


NOTE:
ALL GYP. BD. SHOWN WITHIN THESE ELEVATIONS IS TO BE
PAINTED. UNLESS NOTED OTHERWISE, ALL EXISTING GYP. BD.
SURFACES ARE TO BE PAINTED PT-1, TYPICAL.

TO PAINTING

DATES AND REVISIONS

7/6/12 BID & PERMIT 9/10/12 RE-BID

No. Date/Description

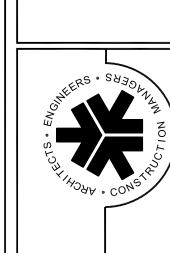


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SERVICE PLAZA DRAWING NO.

A7.1




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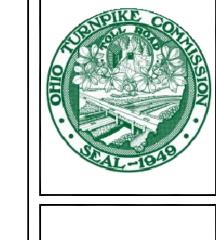
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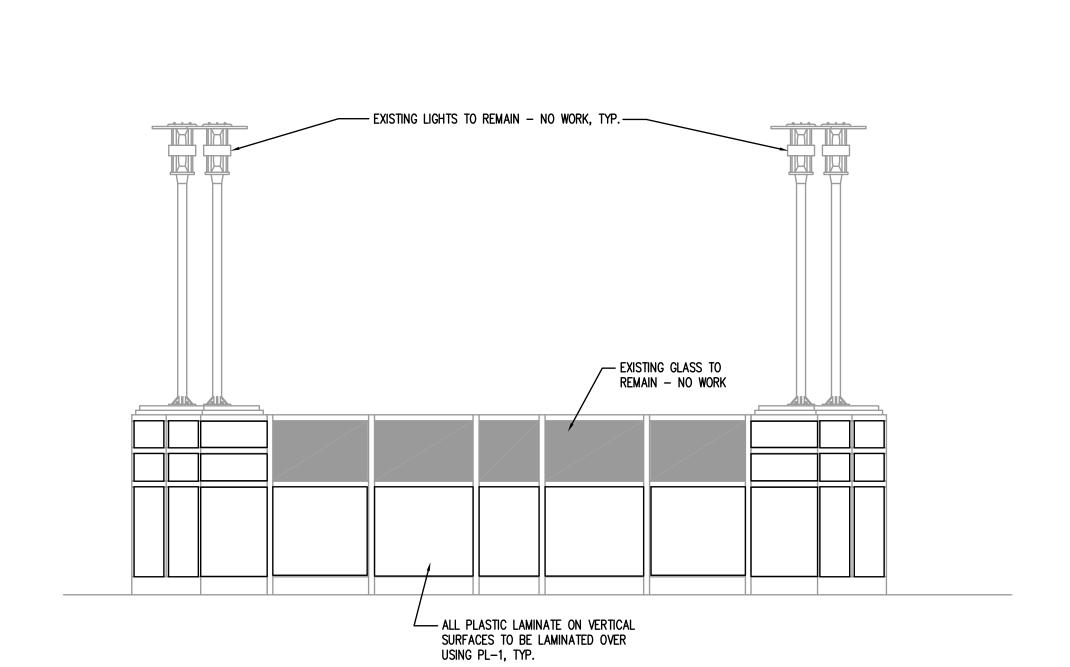
SERVICE PLAZA

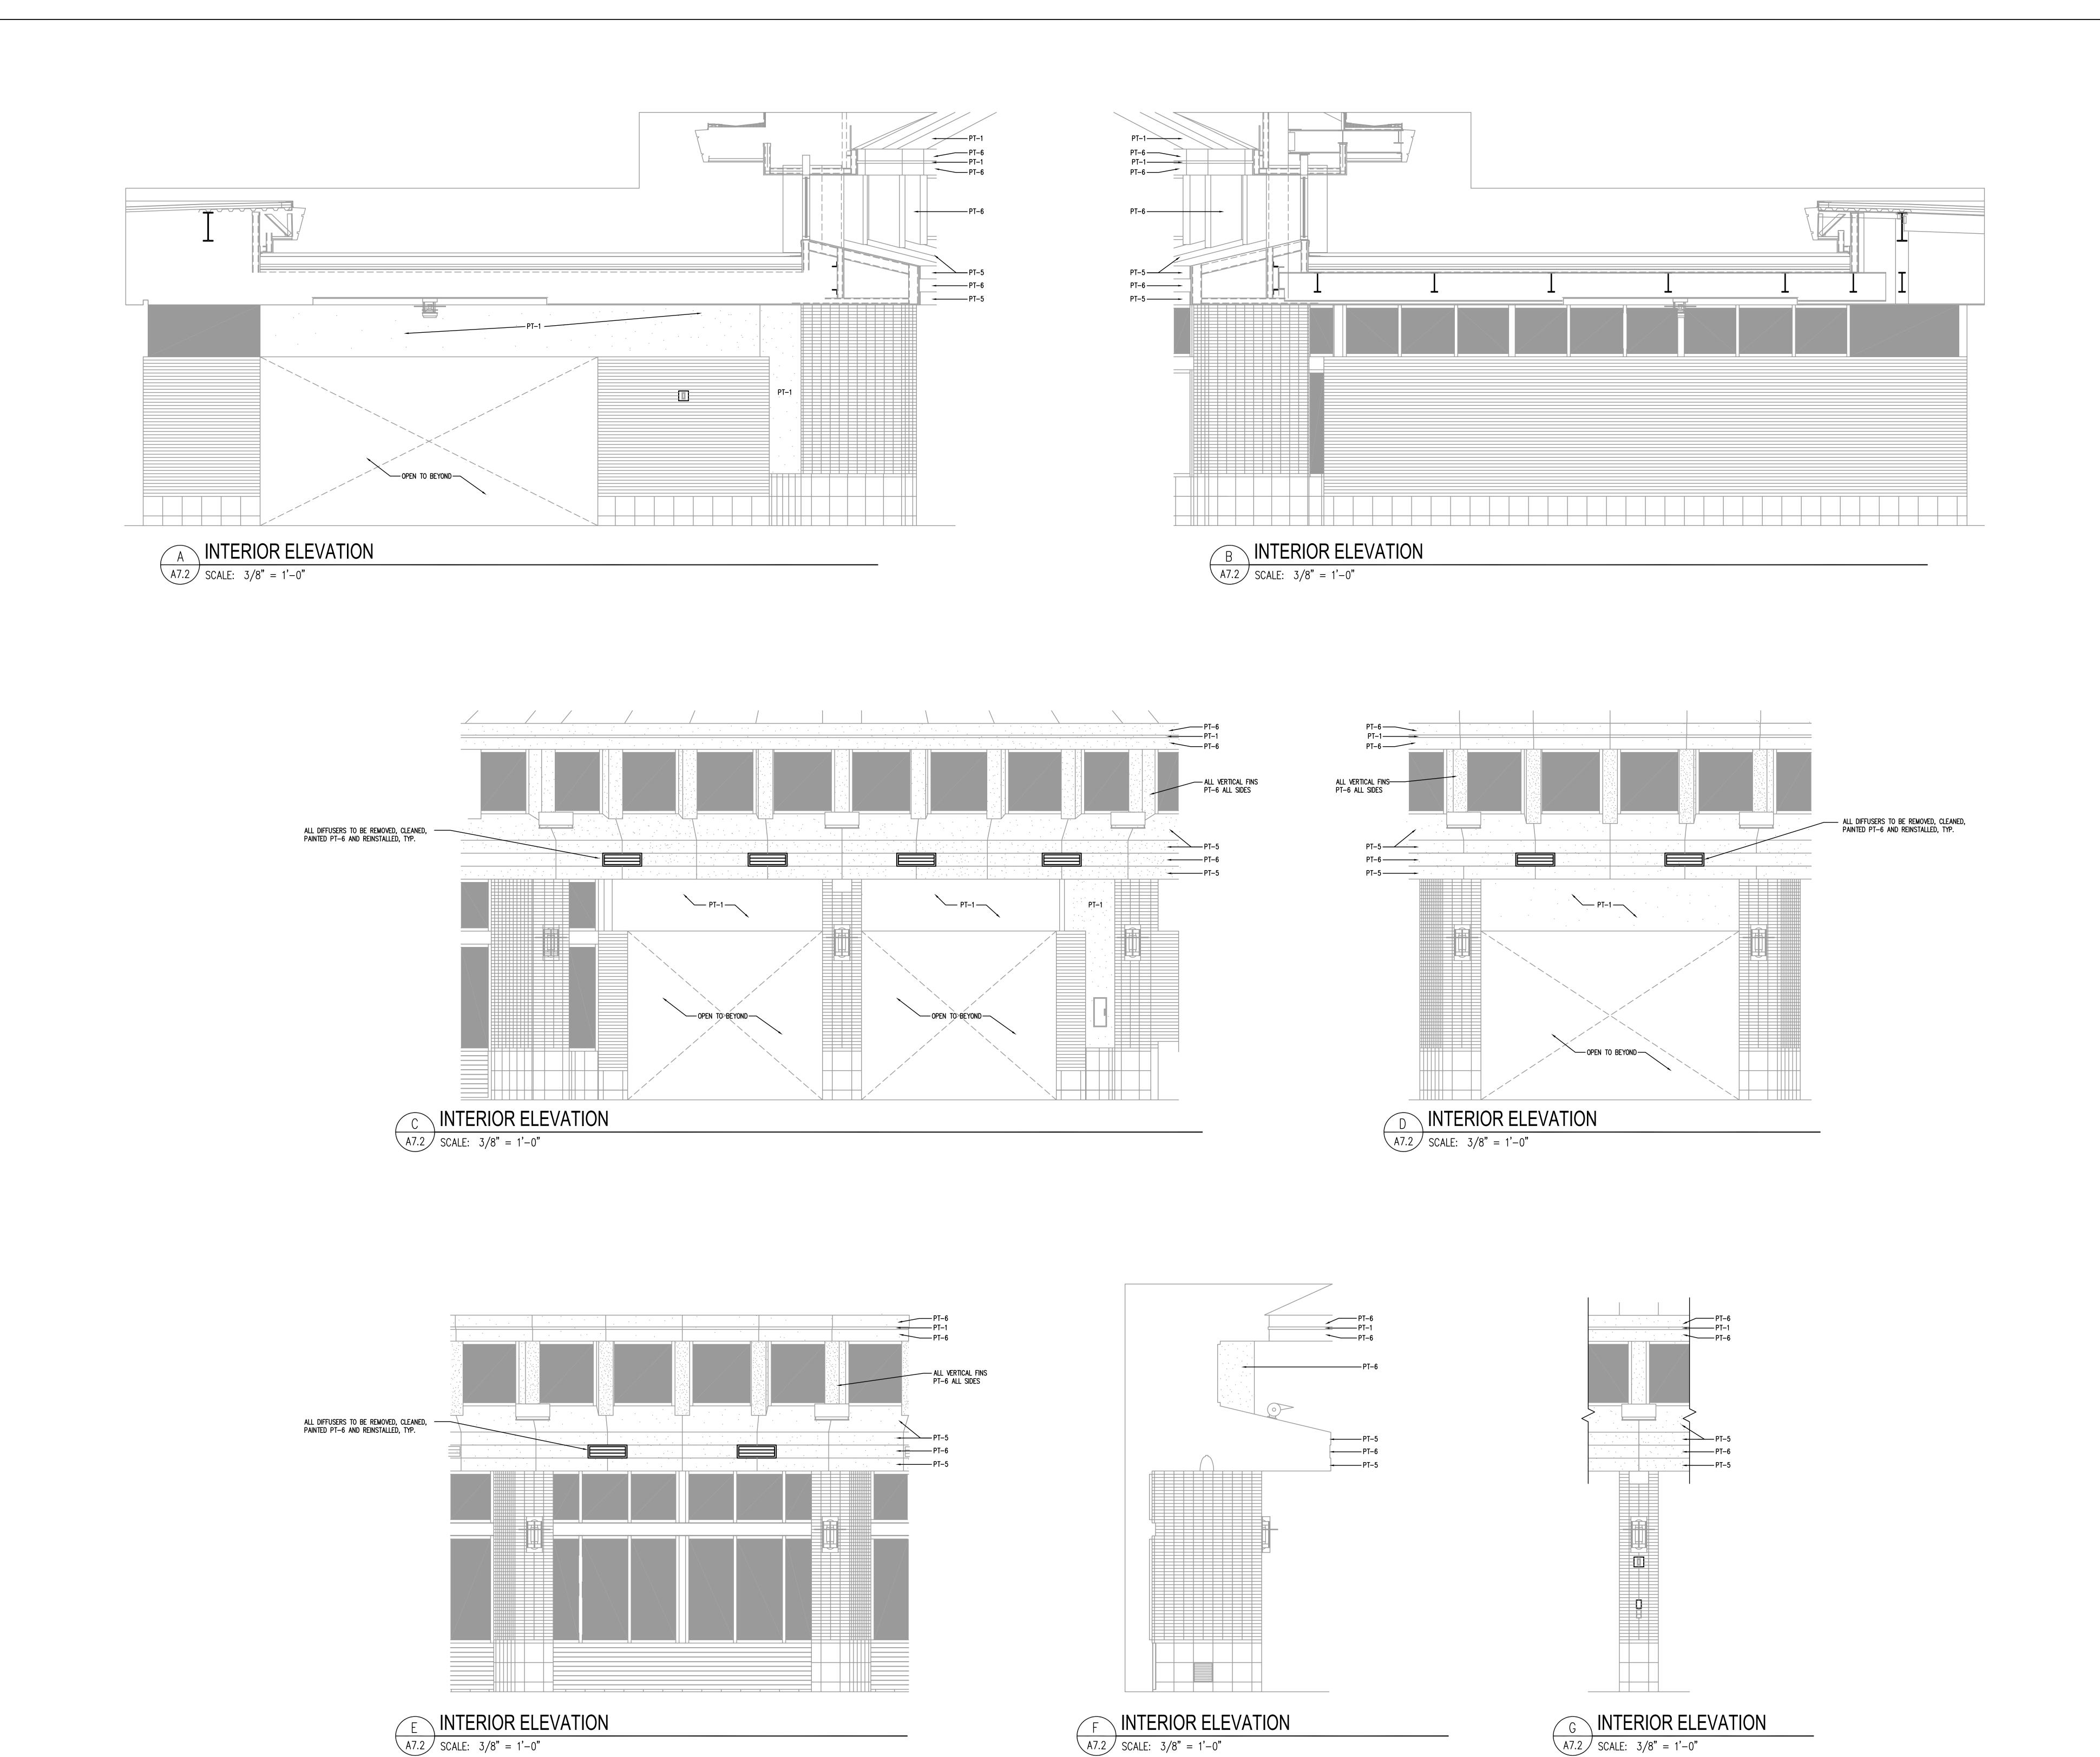





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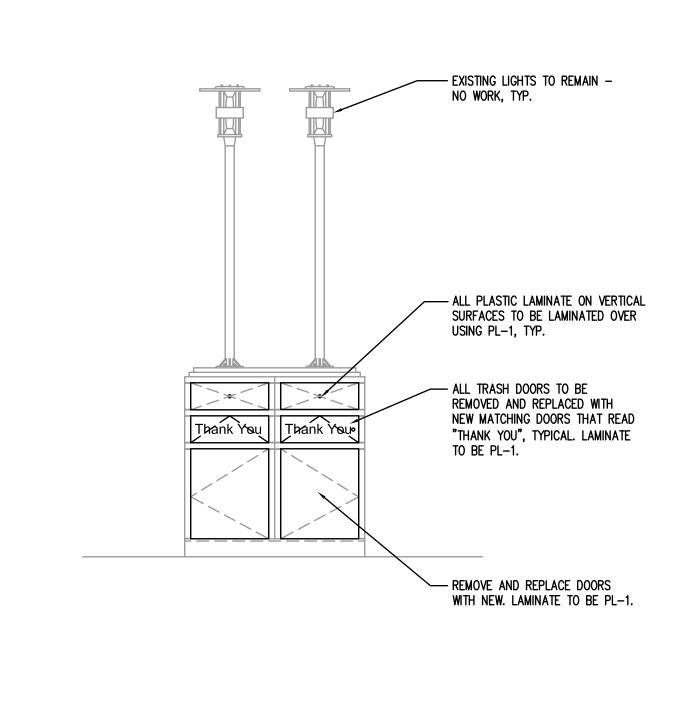
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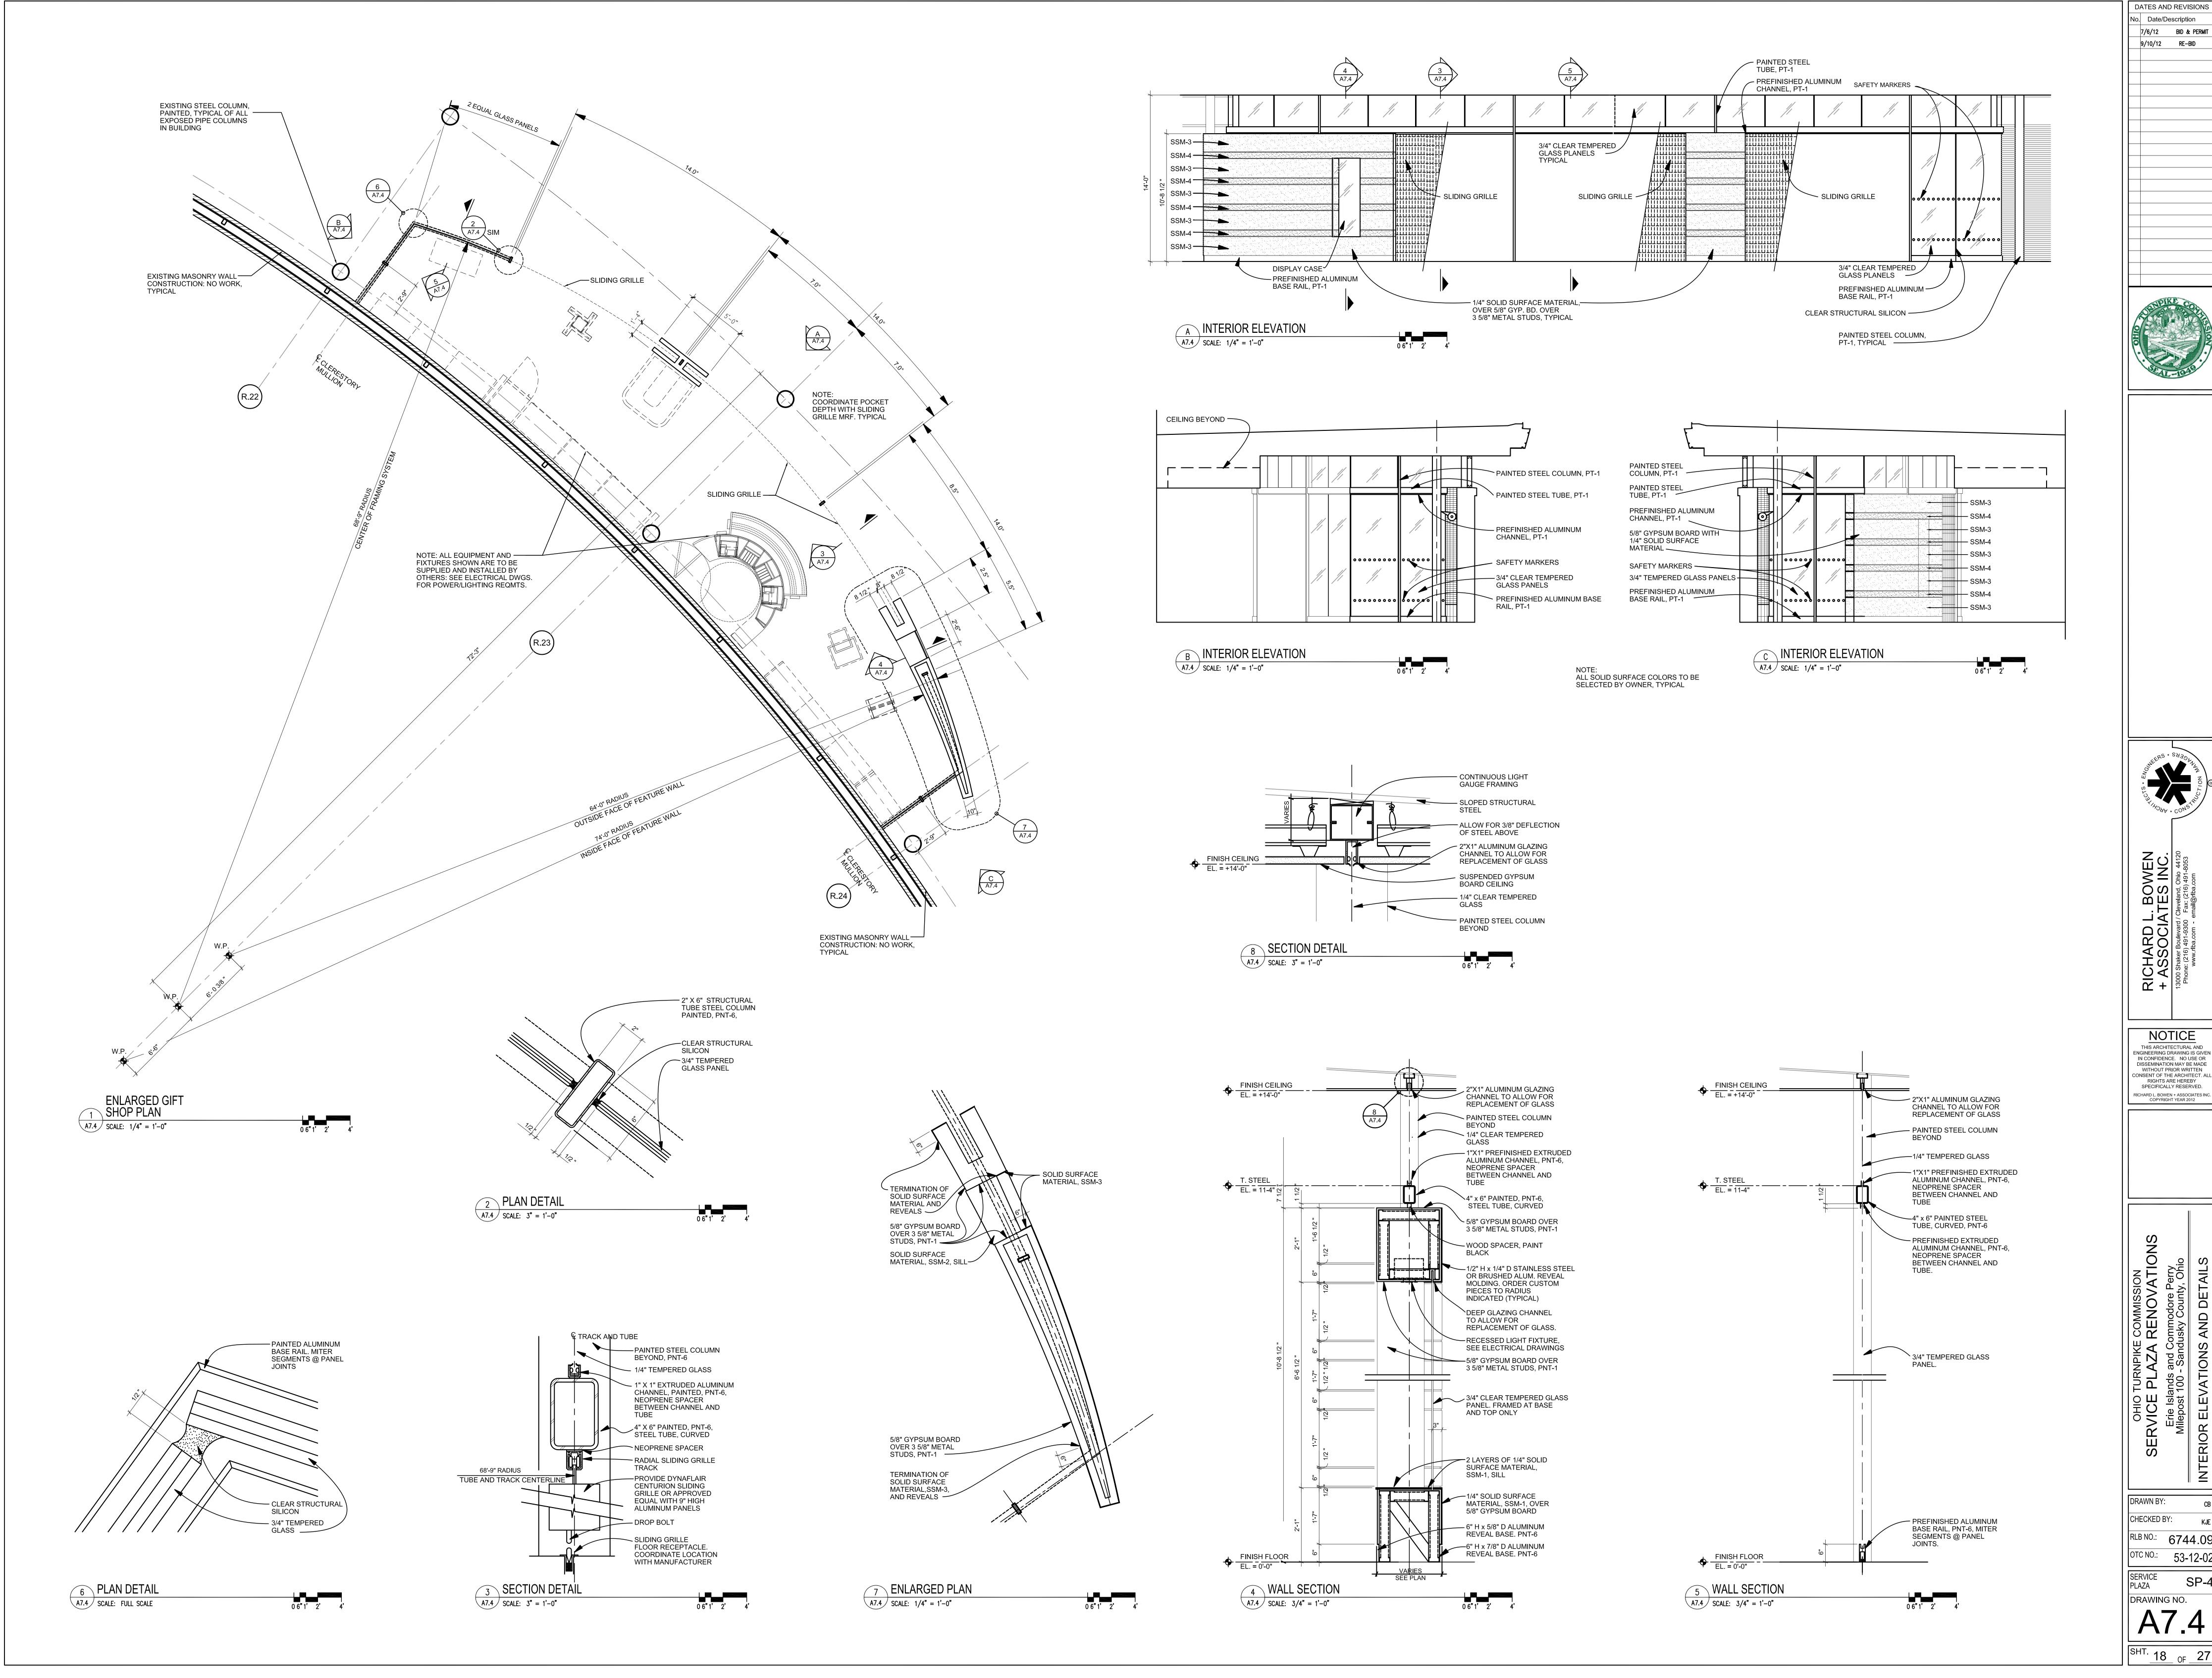



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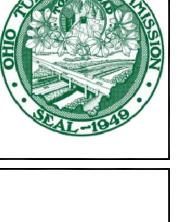
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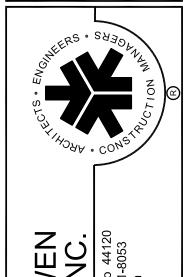
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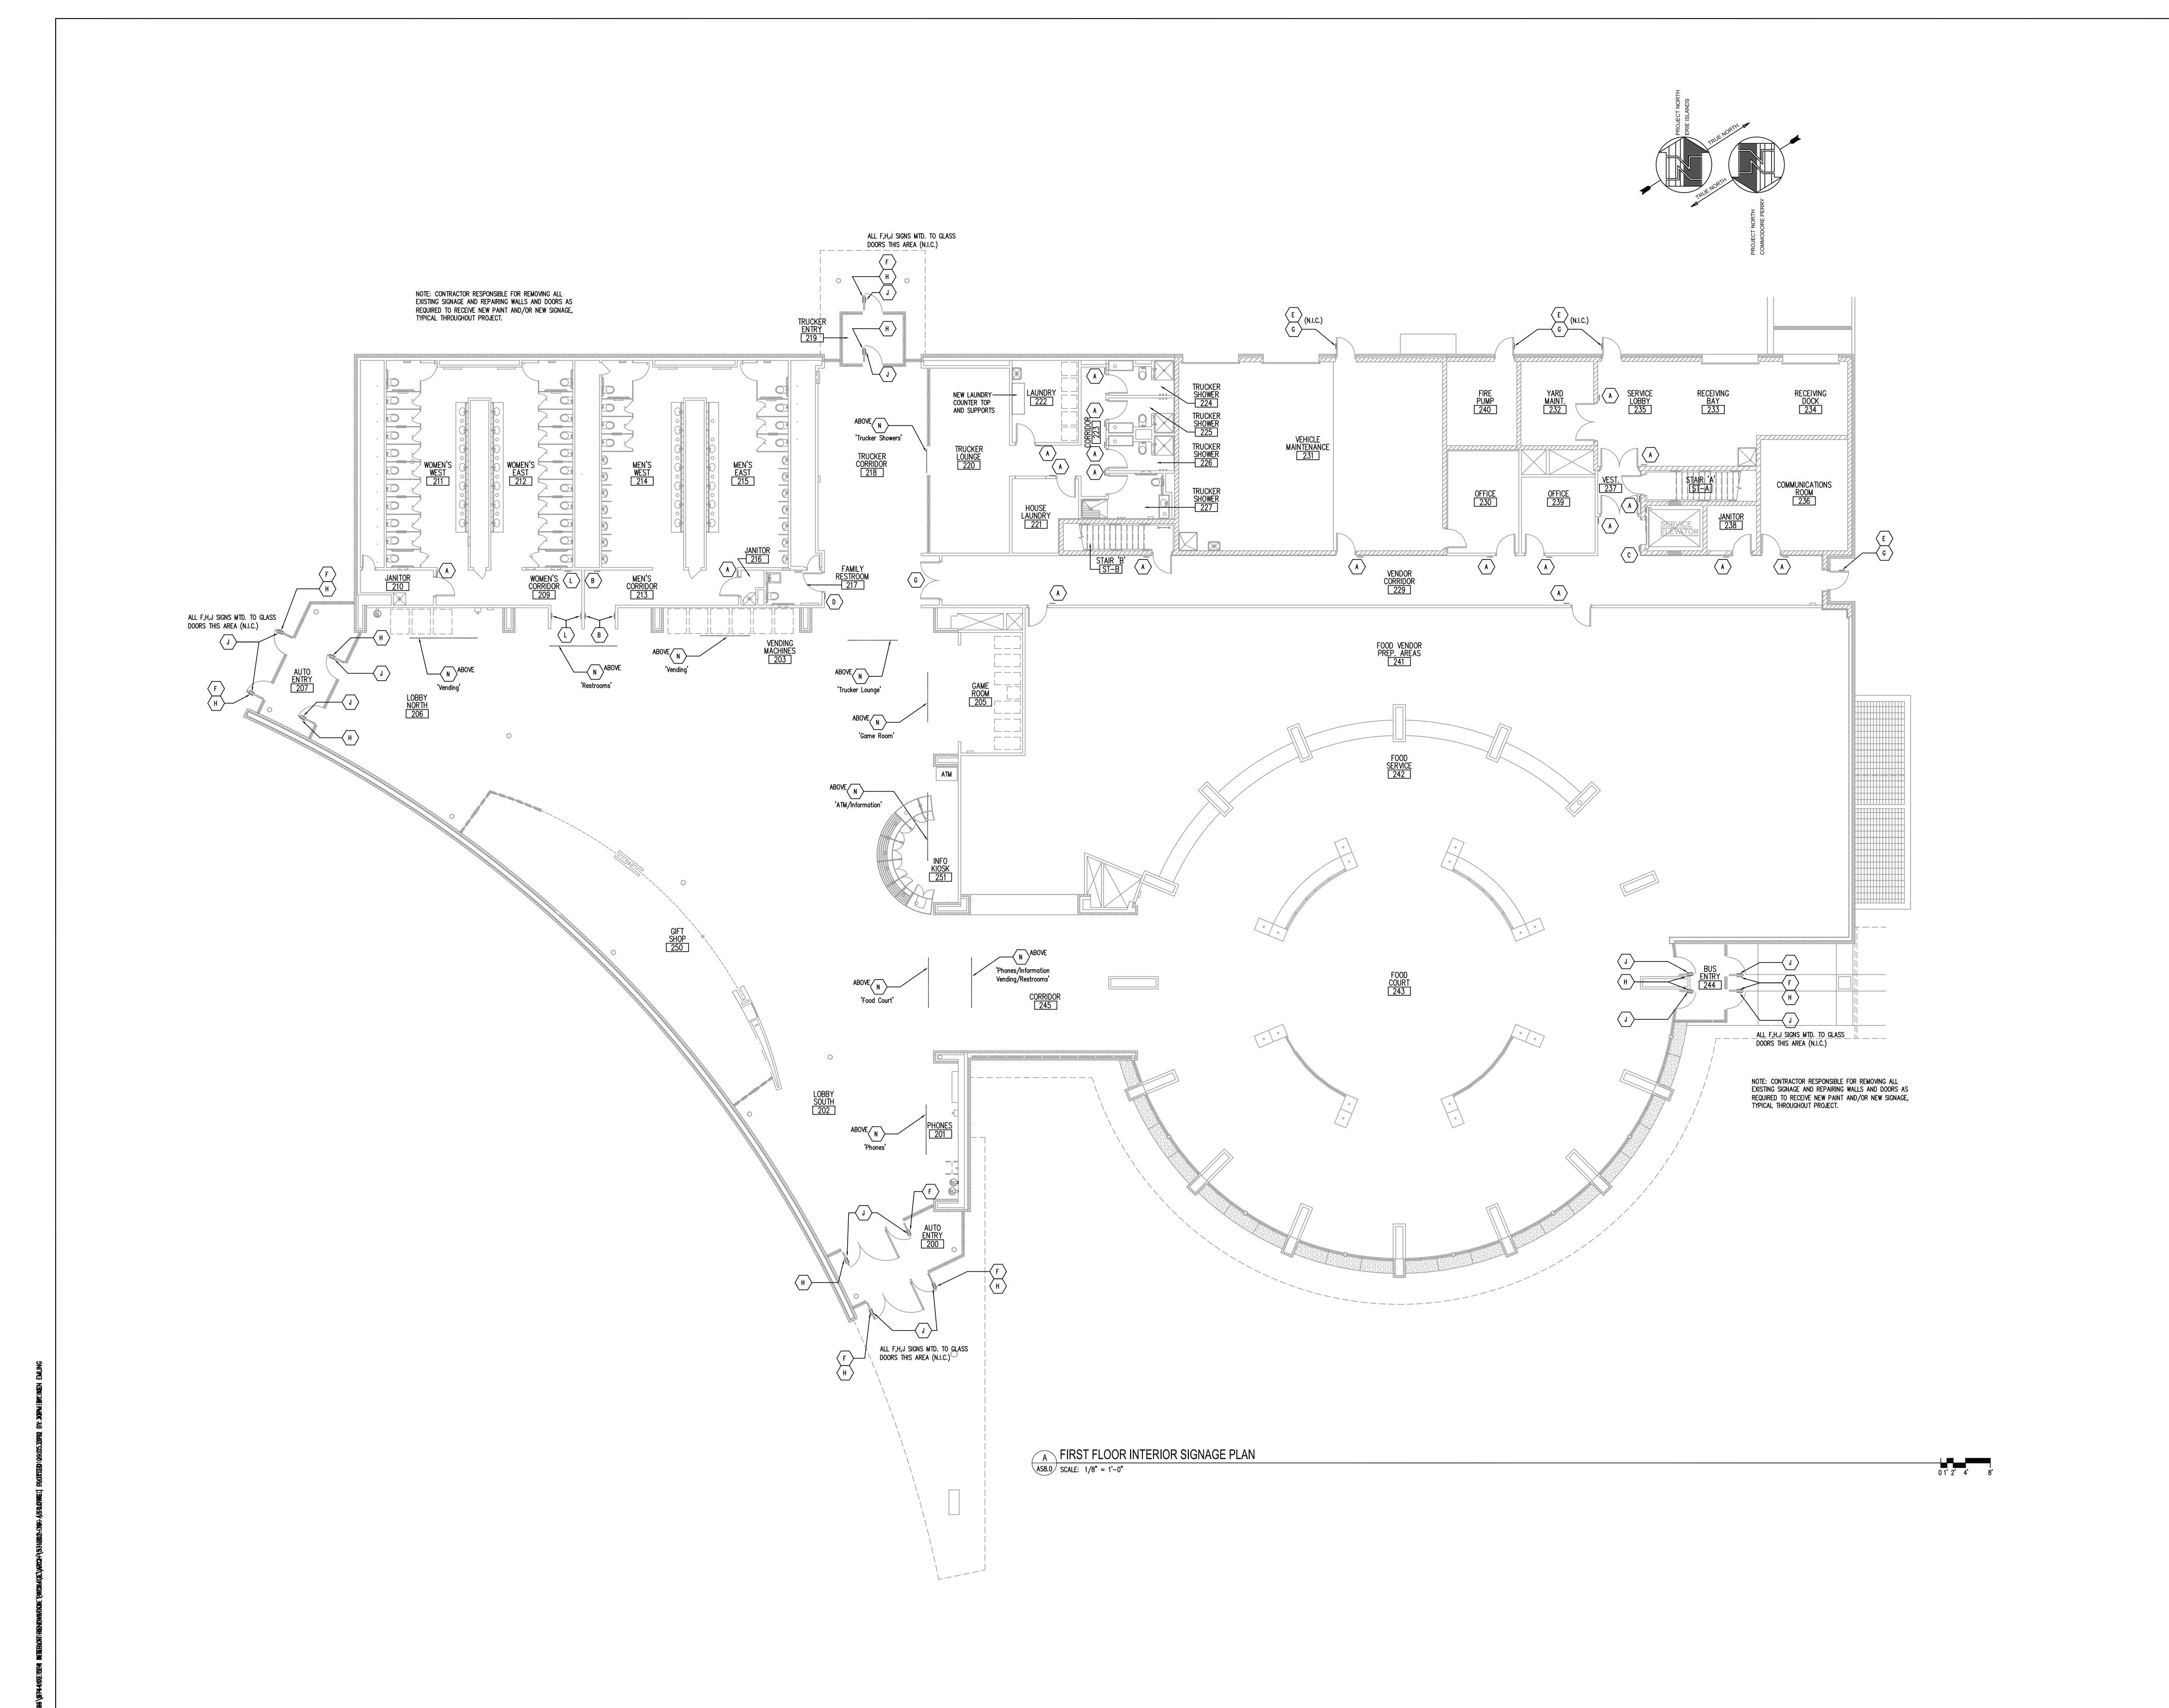


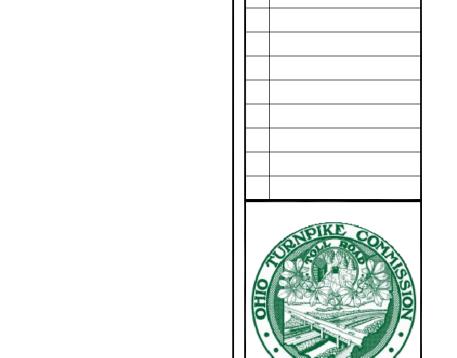
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DRAWING NO. A7.4

SHT. 18 OF 27

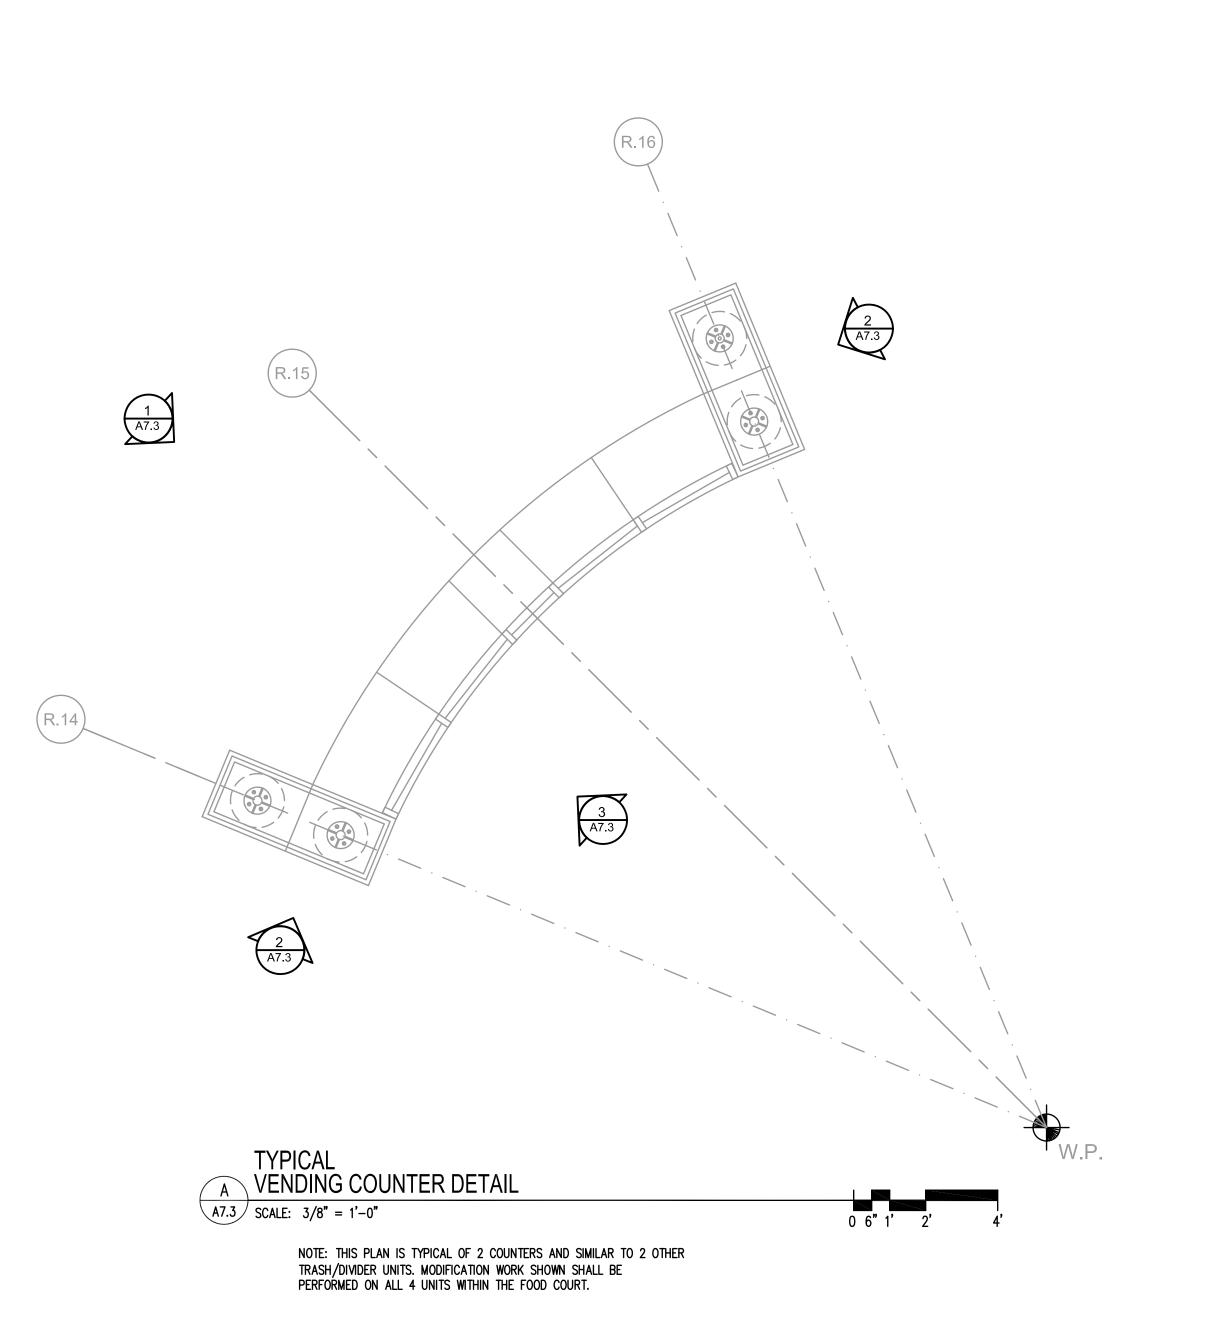


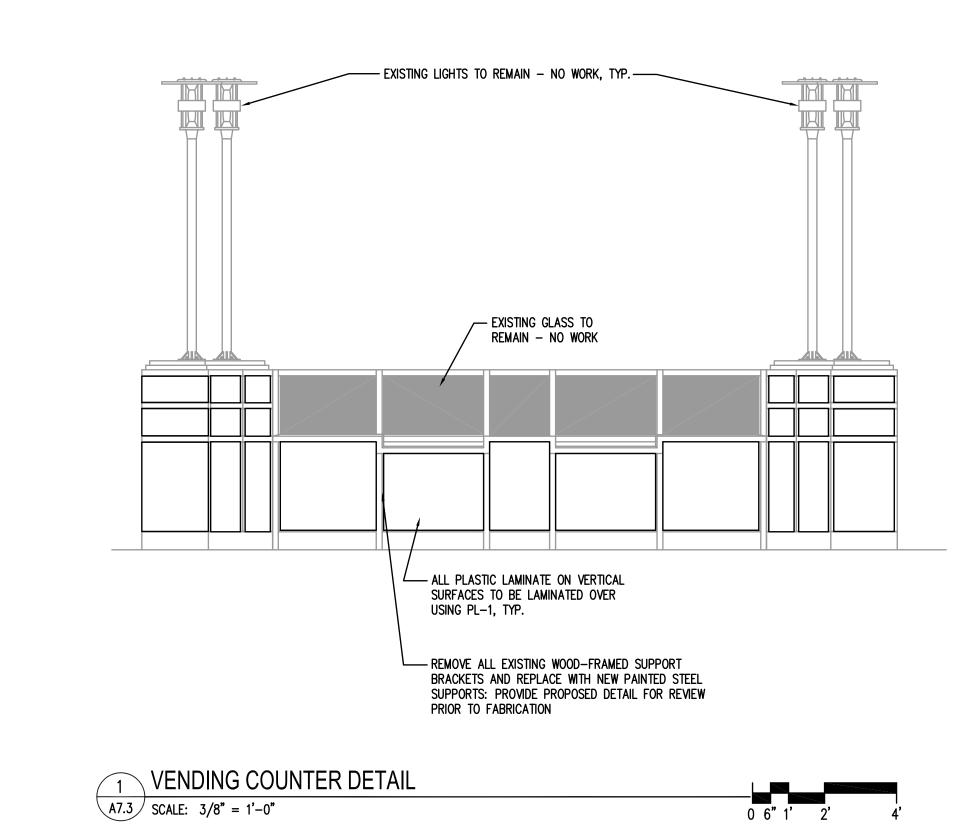
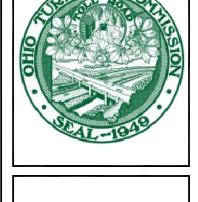
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HCTARD L.

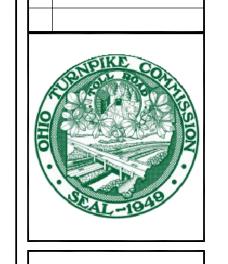+ ASSOCIAT

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Erie Islands and Commodore Perry
Milepost 100 - Sandusky County, Ohio
OOR INTERIOR SIGNAGE PLAN

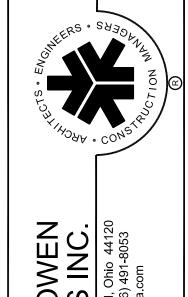
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RLB NO.: 6744.09
OTC NO.: 53-12-02

OTC NO.: 53-12
SERVICE PLAZA

SP

DRAWING NO.


HT. 10 2

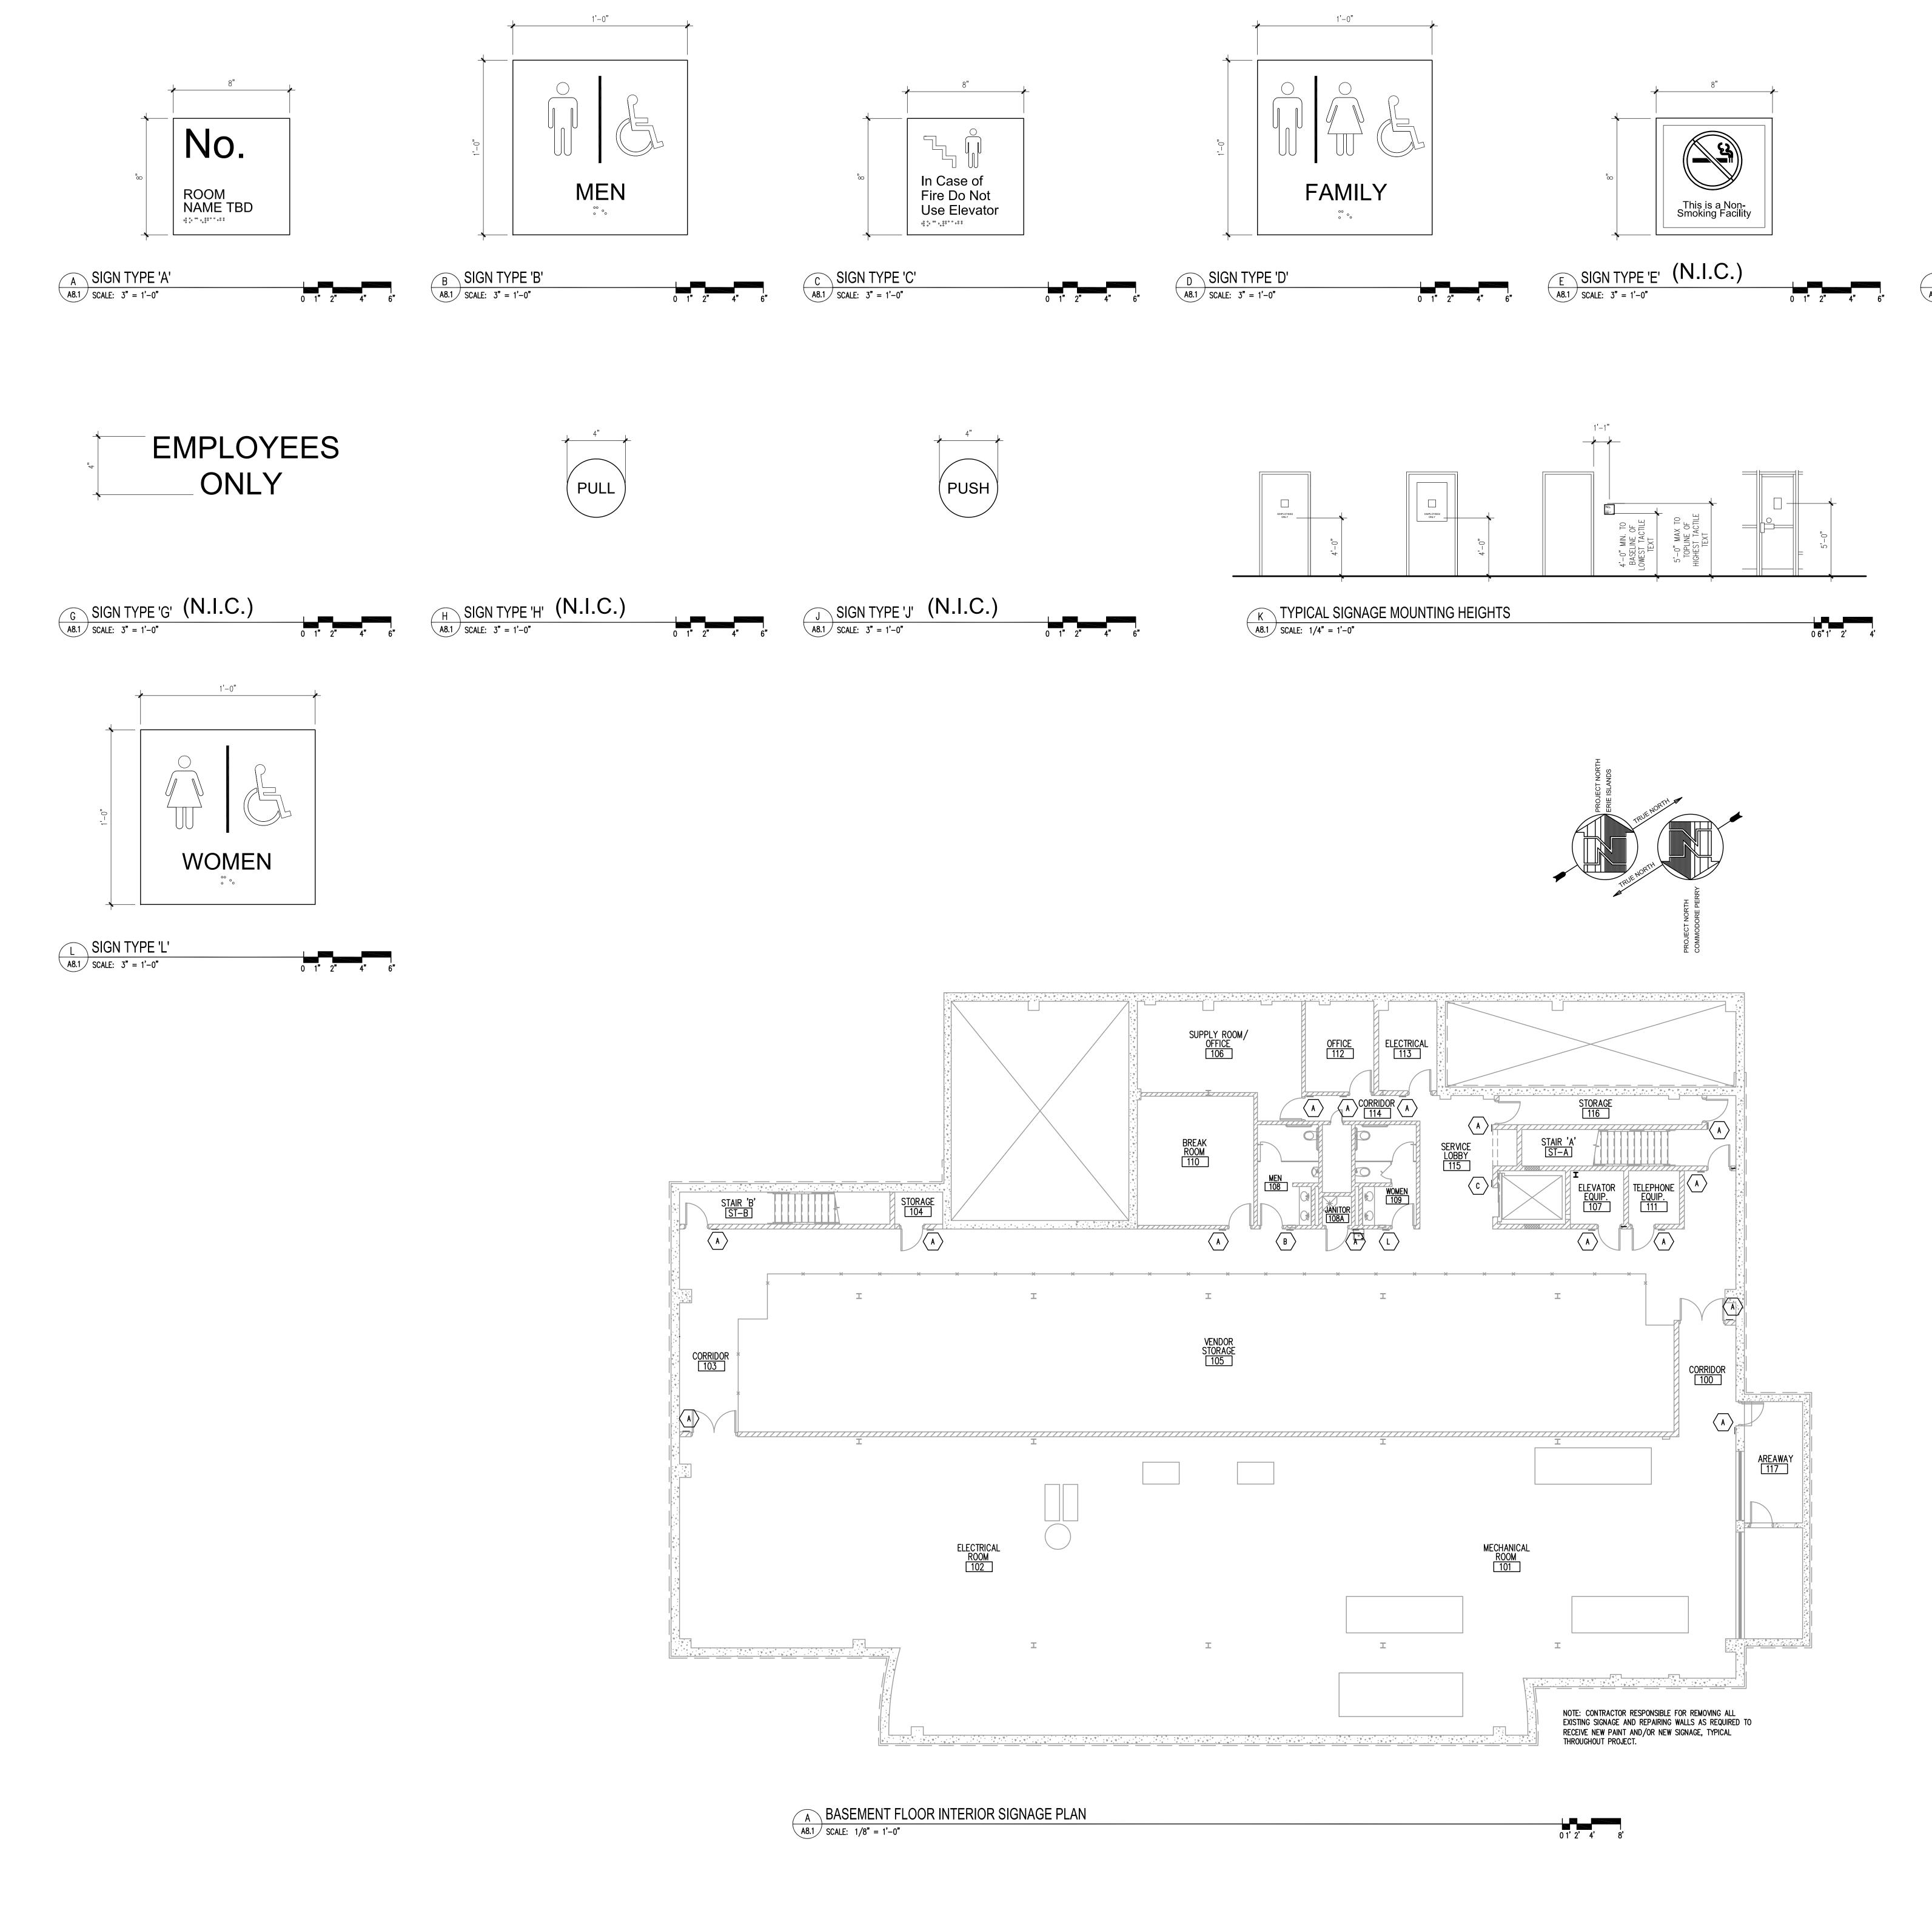

This is a Non-Smoking Facility

Shoes and Shirts
Must Be Worn

No Pets

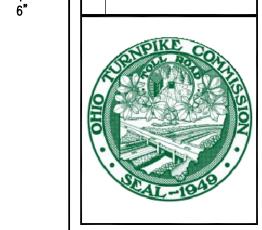

DATES AND REVISIONS

7/6/12 BID & PERMIT

No. Date/Description

9/10/12 RE-BID

GENERAL NOTES:

ROOM NAME AND INFORMATION SIGNS SHALL BE A FRAMELESS PLAQUE LAMINATED TO A .125" ACRYLIC BACKPLATE, ADA READY, WITH EMBOSSED TACTILE GRAPHICS AT .030" DEPTH, INTERIOR / EXTERIOR RATED, WITH SUBSURFACE BACKGROUND COLOR AND PATTERN. (ASI SIGN SYSTEM, ASI ENBOSS, OR EQUAL.)

VINYL SIGNS TO BE COMPUTER, PRECISION CUT FROM SELF ADHESIVE VINYL FILM FOR INTERIOR / EXTERIOR USE.

SIGN TYPES "A", "B", "C", "D" AND "L" SHALL BE FRAMELESS, SUBSURFACE WITH WHITE LETTERING.

BACKGROUND COLOR FOR ALL FRAMELESS SIGNS TO BE ASI SIGN SYSTEMS "STORM BLUE" SC-612, OR EQUAL APPROVED BY ARCHITECT.

SIGN TYPE "E" AND "F" SHALL BE A WHITE VINYL ADHESIVE SIGN WITH BLACK LETTERING.

SIGN TYPE "G" AND "M" TO BE 1" BLACK DIE CUT VINYL LETTERS CENTERED ON DOOR. SEE MOUNTING DETAILS THIS SHEET.

SIGN TYPES "H", AND "J" SHALL BE A VINYL ADHESIVE SIGN WITH WHITE LETTERING. BACKGROUND COLOR SHALL MATCH ASI SIGN SYSTEMS "STORM BLUE" SC-612.


ALL SIGNS TO BE MOUNTED 60" ABOVE FINISH FLOOR TO CENTER OF SIGN.

TYPESTYLE OF SIGN TYPE "N" LETTERS TO BE HUMANIST 521BT - FINAL LAYOUT AND TYPESET TO BE APPROVED BY ARCHITECT PRIOR TO INSTALLATION. COLOR TO MATCH SHERWIN WILLIAMS SW6545 'MAJESTIC PURPLE'. SEE DWG. AS9.1 AND ARCH DWGS. FOR LOCATIONS OF SIGN TYPE "N". CAPITOL LETTERS TO BE 9" IN HEIGHT AND ALL LETTERS TO BE 3/8" THICK, TYP.

GLASS SAFETY MARKERS ARE 2" VINYL SELF-ADHESIVE CIRCLES. PLACE CIRCLES BACK TO BACK 5" O.C., 60" A.F.F., AND CENTERED ON EACH SECTION OF GLASS. CIRCLES ARE TO BE "SAFETY YELLOW" IN COLOR. SEE ARCH. DWGS. FOR LOCATIONS

SUBMIT SIGN SCHEDULE INCLUDING ALL TEXT, ROOM NUMBER, AND QUANTITY OF ALL SIGNS FOR REVIEW PRIOR TO FABRICATION.

FOR ALL SIGNAGE THROUGHOUT THE BUILDING, THE G.T.C. SHALL PROVIDE FIRE TREATED WOOD BLOCKING AS NEEDED FOR ALL SIGNS AND INTERNALLY ILLUMINATED LIGHT/SIGN BOXES, TYPICAL.

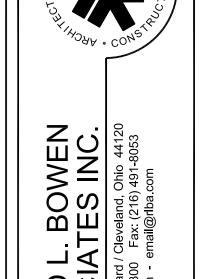

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lepost 100 - Sandusky County, Ohio
T SIGNAGE PLAN AND SIGN TYPES

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RLB NO.: 6744.09


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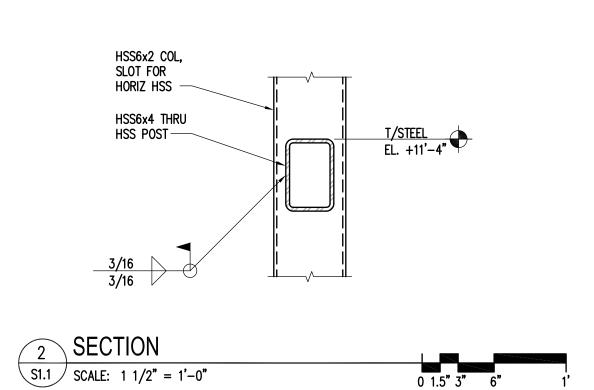
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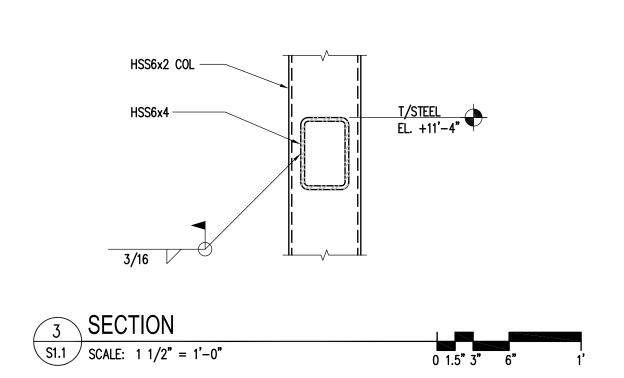
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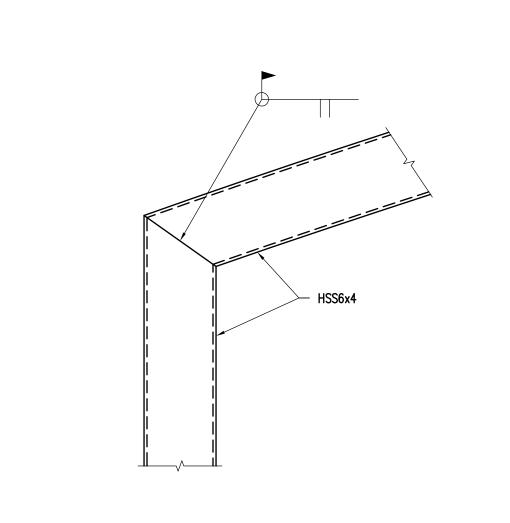
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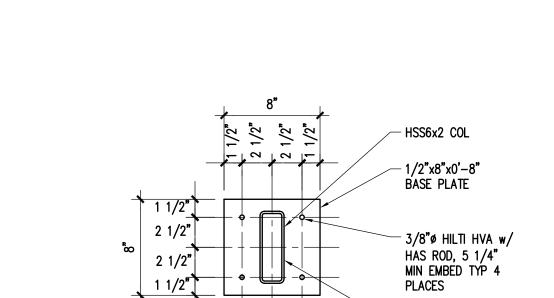
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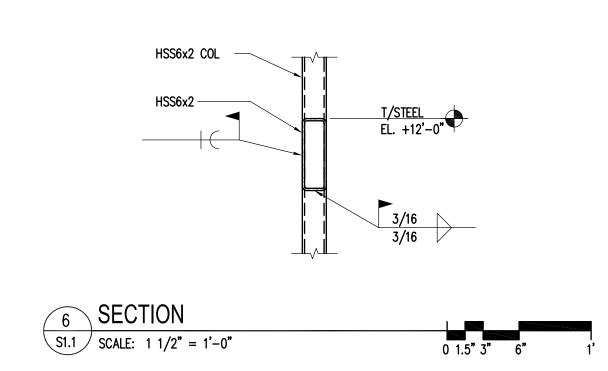






S1.1 SCALE:  $1 \frac{1}{2} = 1'-0''$ 



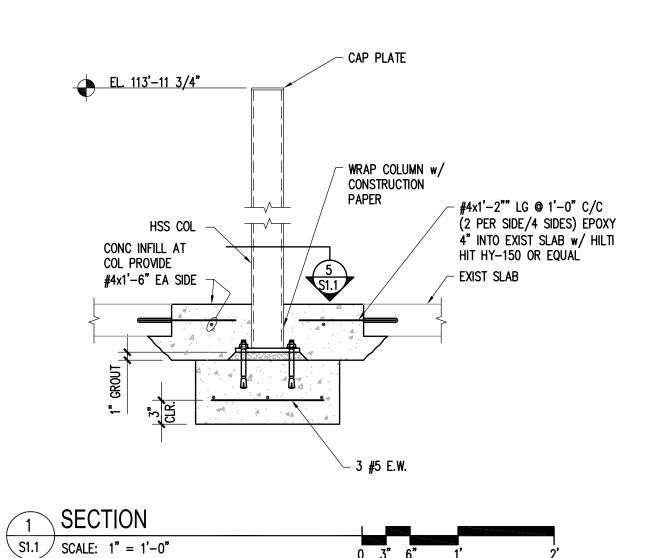

# STRUCTURAL GENERAL NOTES

#### GENERAL

REFER TO SPECIFICATIONS FOR: QUALITY OF WORK; PERFORMANCE; STRENGTH AND PHYSICAL REQUIREMENTS FOR MATERIALS; STANDARDS, CODES AND REGULATIONS; GUARANTEES. REFER TO ARCHITECTURAL DRAWINGS FOR OTHER PERTINENT INFORMATION RELATED TO STRUCTURAL WORK. THE MOST STRINGENT REQUIREMENTS APPLY IN CASE OF CONFLICT AMONG SPECIFICATIONS, STANDARDS, CODES AND DRAWINGS. VERIFY DETAILS, DIMENSIONS AND WEIGHTS OF PURCHASED EQUIPMENT AS IT RELATES TO INFORMATION GIVEN ON STRUCTURAL DRAWINGS RELATIVE TO SUCH EQUIPMENT. PROMPTLY NOTIFY ARCHITECT IN WRITING OF ANY CONFLICT IN INTERPRETATION OF CONTRACT DOCUMENTS. VERIFY DIMENSIONS AND CONDITIONS RELATING TO SITE, EXISTING CONSTRUCTION AND EXISTING UTILITIES AND SERVICES PRIOR TO START OF CONSTRUCTION. CONTRACTOR HAS FINAL AUTHORITY ON MEANS, METHODS, TECHNIQUES, SEQUENCES AND PROCEDURES OF CONSTRUCTION, AND IS RESPONSIBLE FOR SAFETY PRECAUTIONS ON THE

STRUCTURAL ENGINEER HAS FINAL AUTHORITY ON MATTERS OF LOADING IN GENERAL, DESIGN REQUIREMENTS, AND ON MATTERS RELATING TO STABILITY. CHANGES, MODIFICATIONS SUBMIT WRITTEN REQUEST TO THE ARCHITECT FOR APPROVAL OF ANY PROPOSED CHANGE TO THE REQUIREMENTS OF THE CONTRACT DOCUMENTS. SPLICING, CUTTING, NOTCHING AND OTHER ALTERATIONS TO STRUCTURAL MEMBERS ARE NOT PERMITTED WITHOUT WRITTEN AUTHORIZATION OF THE STRUCTURAL ENGINEER.

ANY AUTHORIZED DEVIATION FROM THE CONTRACT DOCUMENTS, AND CORRECTION THEREOF, IS THE RESPONSIBILITY OF THE CONTRACTOR.

### SHOP DRAWINGS

REINFORCING BARS:

SHOP DRAWING REVIEW IS FOR CONFORMANCE WITH THE PROJECT CONTRACT DOCUMENTS AND DOES NOT RELIEVE THE CONTRACTOR FROM COMPLIANCE WITH THE DRAWINGS, SPECIFICATIONS, AND GOVERNING BUILDING CODES. SHOP DRAWINGS SUBMITTED WITHOUT THE GENERAL CONTRACTOR'S CHECKING, COORDINATION, AND \*APPROVED\* STAMP WILL BE RETURNED WITHOUT REVIEW. CAST-IN-PLACE CONCRETE

ASTM A615, GRADE 60

MINIMUM ULTIMATE COMPRESSIVE STRENGTH OF CONCRETE AT 28 DAYS SHALL BE: 3000 PSI 4000 PSI UNLESS NOTED

PROVIDE PLASTIC-TIPPED BAR SUPPORTS OF ADEQUATE STRENGTH AND SPACING TO SUPPORT THE WEIGHT OF REINFORCING BARS AND WORKERS. PLACE FIRST SUPPORT NO FARTHER THAN 12" (30 cm) FROM ENDS OF REINFORCING BARS. FOLLOW ACI 318 AND ACI 315 FOR DETAILS OF AND SUPPORTS FOR REINFORCEMENT. SPLICE REINFORCING BARS ONLY WHERE SHOWN ON THE DRAWINGS. WHERE CONTINUOUS REINFORCING IS CALLED OUT, REINFORCING MAY BE SPLICED IF APPROVED BY THE STRUCTURAL ENGINEER. SPLICES: PROVIDE THE FOLLOWING MINIMUM REINFORCING BAR LAP SPLICES EXCEPT AS NOTED OR UNLESS OTHERWISE SHOWN ON DRAWINGS (MS = MECHANICAL SPLICE).

TOP BARS:		#3	<b>#4</b>	<b>#</b> 5	<b>#</b> 6	<b>#</b> 7	#8
3000 PSI	CONCRETE	21"	28"	35"	46"	63 <b>"</b>	82 <b>"</b>
4000 PSI	CONCRETE	18"	24"	30"	40"	54"	71"
ALL OTHER	BARS:	#3	#4	<b>#</b> 5	<b>#</b> 6	<b>#</b> 7	<b>#</b> 8
3000 PSI	CONCRETE	16"	22"	27"	35"	48"	63 <b>"</b>
4000 PSI	CONCRETE	16"	19"	23"	31"	42"	55"

CORNER BARS SHALL BE PROVIDED AT ALL INTERSECTING AND CORNER WALL AND BEAM LOCATIONS. CORNER BARS SHALL BE THE SAME SIZE AND SPACING AS THE HORIZONTAL REINFORCING STEEL. PROVIDE 2-#4 TOP BARS IN BEAMS WHERE NO OTHER BARS ARE AVAILABLE FOR SUPPORTING STIRRUPS.

PROVIDE THE FOLLOWING CONCRETE COVER OVER REINFORCING BARS, UNLESS OTHERWISE SHOWN ON THE DRAWINGS: FOOTING OR MAT SURFACES CAST AGAINST EARTH: FOOTING OR MAT SURFACES CAST AGAINST FORM WORK:

CONCRETE SURFACES EXPOSED TO WEATHER, EARTH, MOISTURE OR CORROSIVE ENVIRONMENTS: #5 BARS OR SMALLER: #6 BARS OR LARGER:

# CONCRETE SURFACES NOT EXPOSED TO WEATHER, EARTH, MOISTURE OR CORROSIVE ENVIRONMENTS:


CHAMFER EXPOSED EDGES OF CONCRETE 3/4" DIAGONAL, UNLESS DETAILED OTHERWISE. REFER TO ARCHITECTURAL DRAWINGS FOR LOCATION, TYPE AND EXTENT OF FINISHES OR OTHER TREATMENT OF EXPOSED CONCRETE. PROVIDE DIAMOND OR ROUND SHAPED CONSTRUCTION JOINTS AROUND ALL COLUMNS WHEN PLACING SLAB-ON-GRADE CONCRETE. POUR SLAB SECTION INSIDE THESE CONSTRUCTION JOINTS AFTER SAW-CUTTING THE SPECIFIED CONTROL JOINTS. PROTECT BASES AND BASE PLATES OF ALL STEEL COLUMNS WITH A MINIMUM OF 4" THICK CONCRETE BETWEEN THE SLAB-ON-GRADE AND THE TOP OF THE FOOTING. ALL CONCRETE EXPOSED TO THE WEATHER OR IN A LOCATION VULNERABLE TO DEICERS SHALL CONTAIN AN AIR-ENTRAINED ADMIXTURE CONFORMING TO ASTM C260. THE AMOUNT OF ENTRAINED AIR SHALL BE  $6\% \pm 1\%$ .


#### STRUCTURAL STEEL

MATERIALS:			
SHAPES:	ASTM SPECIFICATIONS:	MIN. Fy (KSI):	MIN. Fu
RECTANGULAR HSS:	A500 GRADE B	46	58
PLATE:	A36	36	58

WELDING ELECTRODES: E70, COMPLYING WITH TABLE 3.1 OF AWS D1.1 STRUCTURAL STEEL PRIMER PAINT: MODIFIED ALKYD PRIMER, WITH MINIMUM 50% SOLIDS. SEE PROJECT SPECIFICATIONS FOR COVERAGE RATES. FOR STEEL DESIGNATED "AESS" USE AN ORGANIC-URETHANE, ZINC RICH PRIMER.

MODIFICATIONS TO DETAILS OF CONNECTIONS AND SPLICES ARE NOT PERMITTED WITHOUT WRITTEN AUTHORIZATION OF THE STRUCTURAL ENGINEER. REFER TO SPECIFICATION SECTION 05100, "STRUCTURAL STEEL" FOR FURTHER REQUIREMENTS PERTAINING TO DESIGN OF CONNECTIONS. DO NOT FLAME CUT HOLES OR ENLARGE HOLES BY BURNING. DRILL HOLES IN BEARING PLATES. ONE SIDED CONNECTIONS ARE NOT PERMITTED, UNLESS SPECIFICALLY DETAILED ON THE DRAWINGS. IMMMEDIATELY AFTER ERECTION, CLEAN FIELD WELDS, BOLTED CONNECTIONS, AND ABRADED AREAS OF SHOP PAINT. APPLY PAINT TO EXPOSED AREAS WITH THE SAME MATERIAL USED FOR SHOP PAINTING. APPLY BY BRUSH OR SPRAY TO PROVIDE A MINIMUM DRY FILM THICKNESS OF 2.0 MILLS.

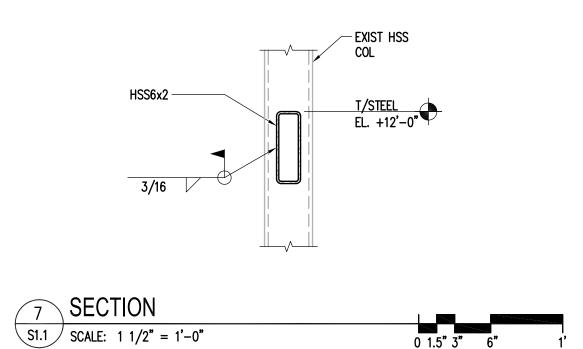


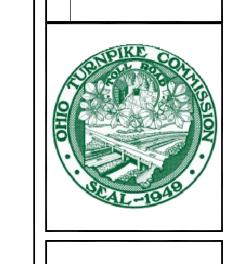

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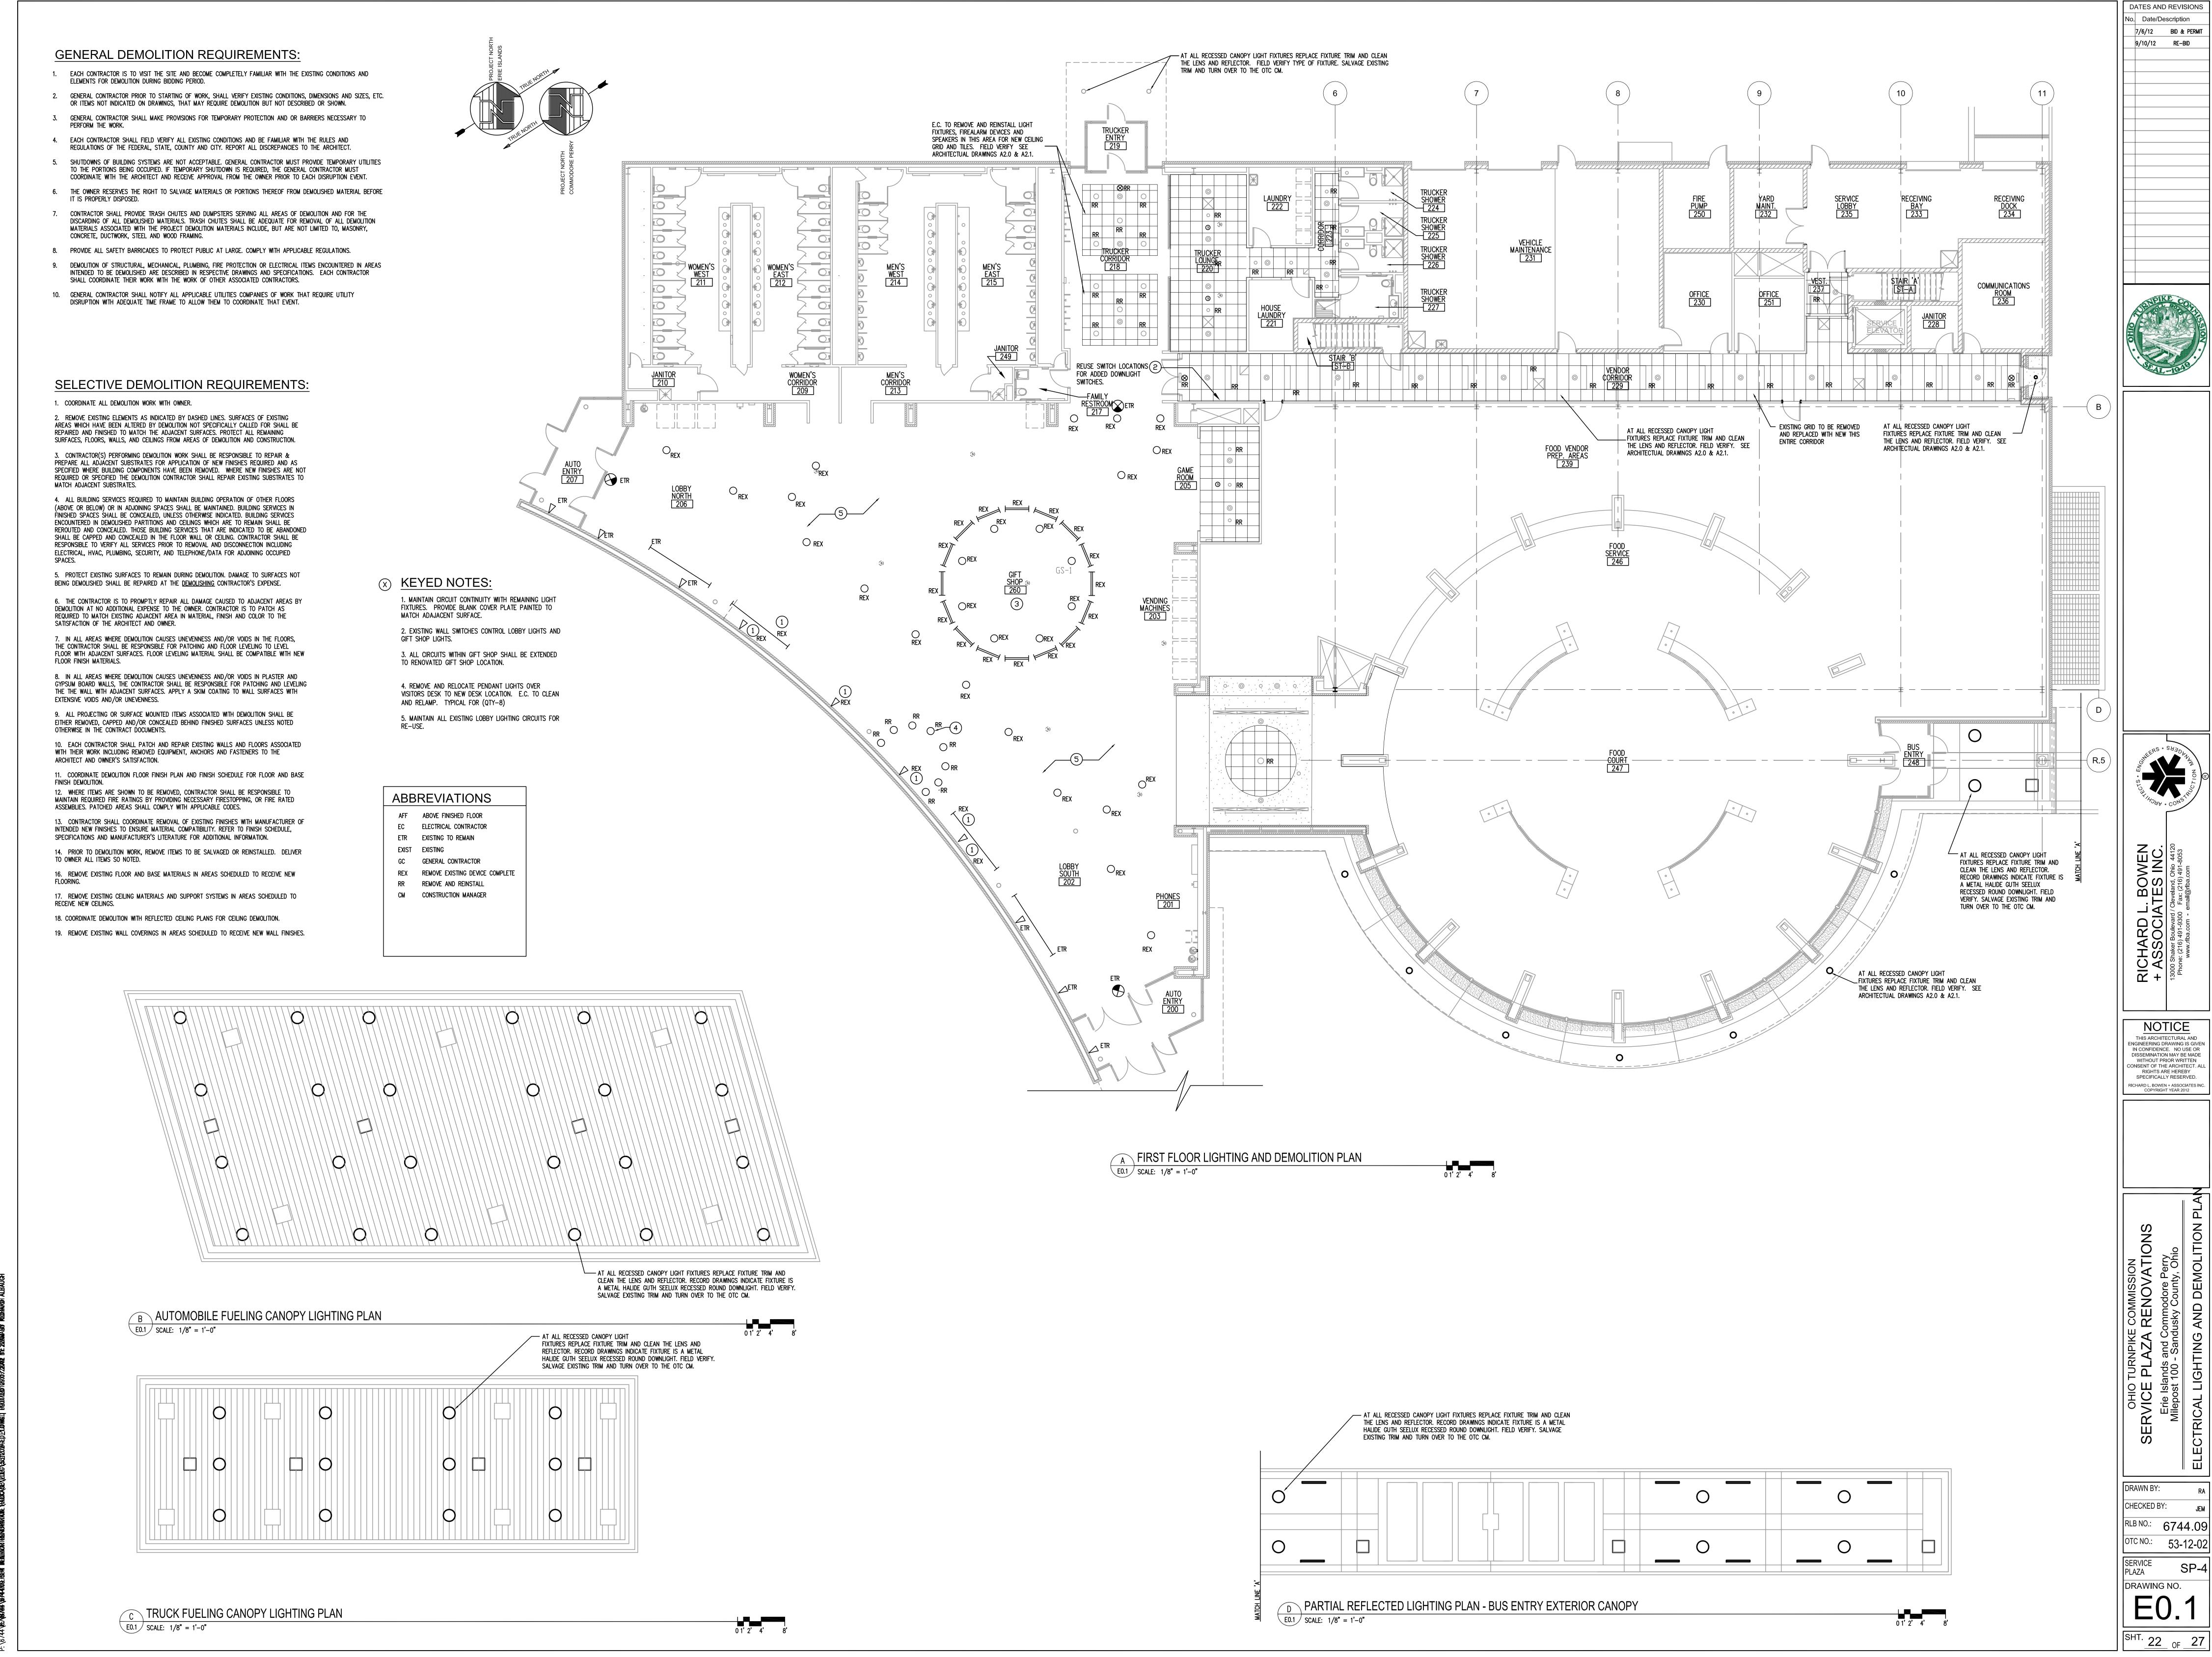
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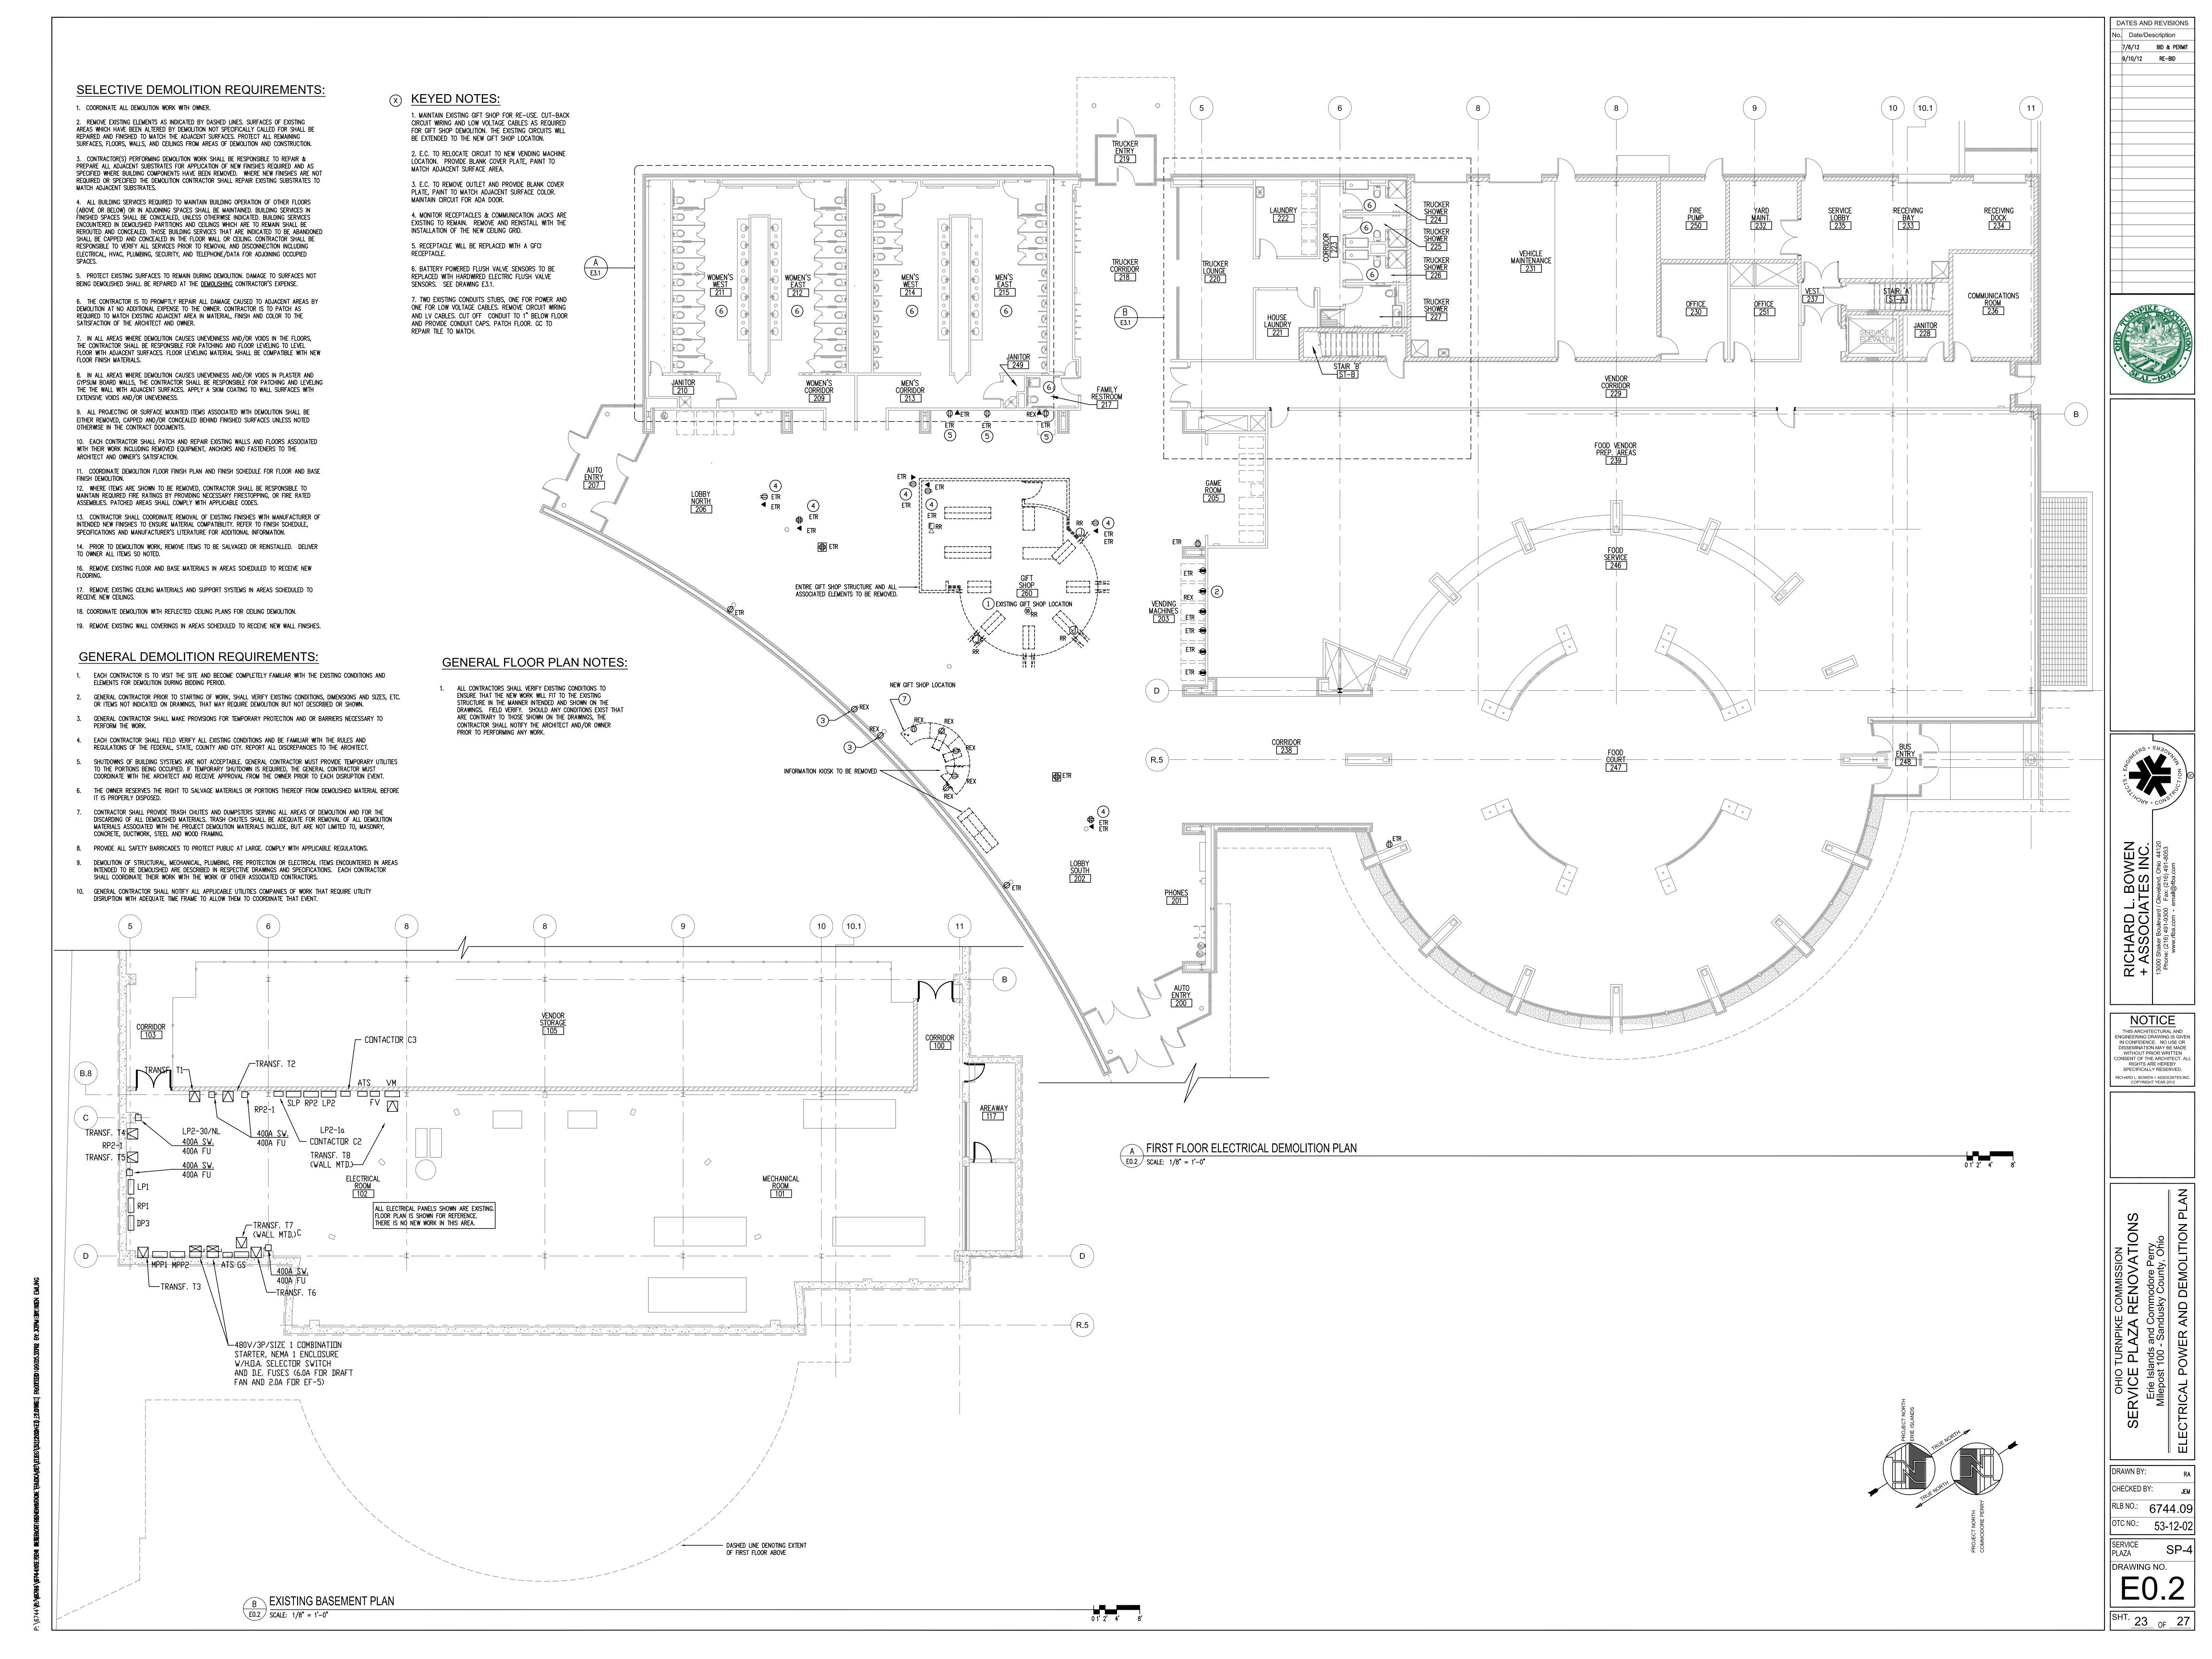



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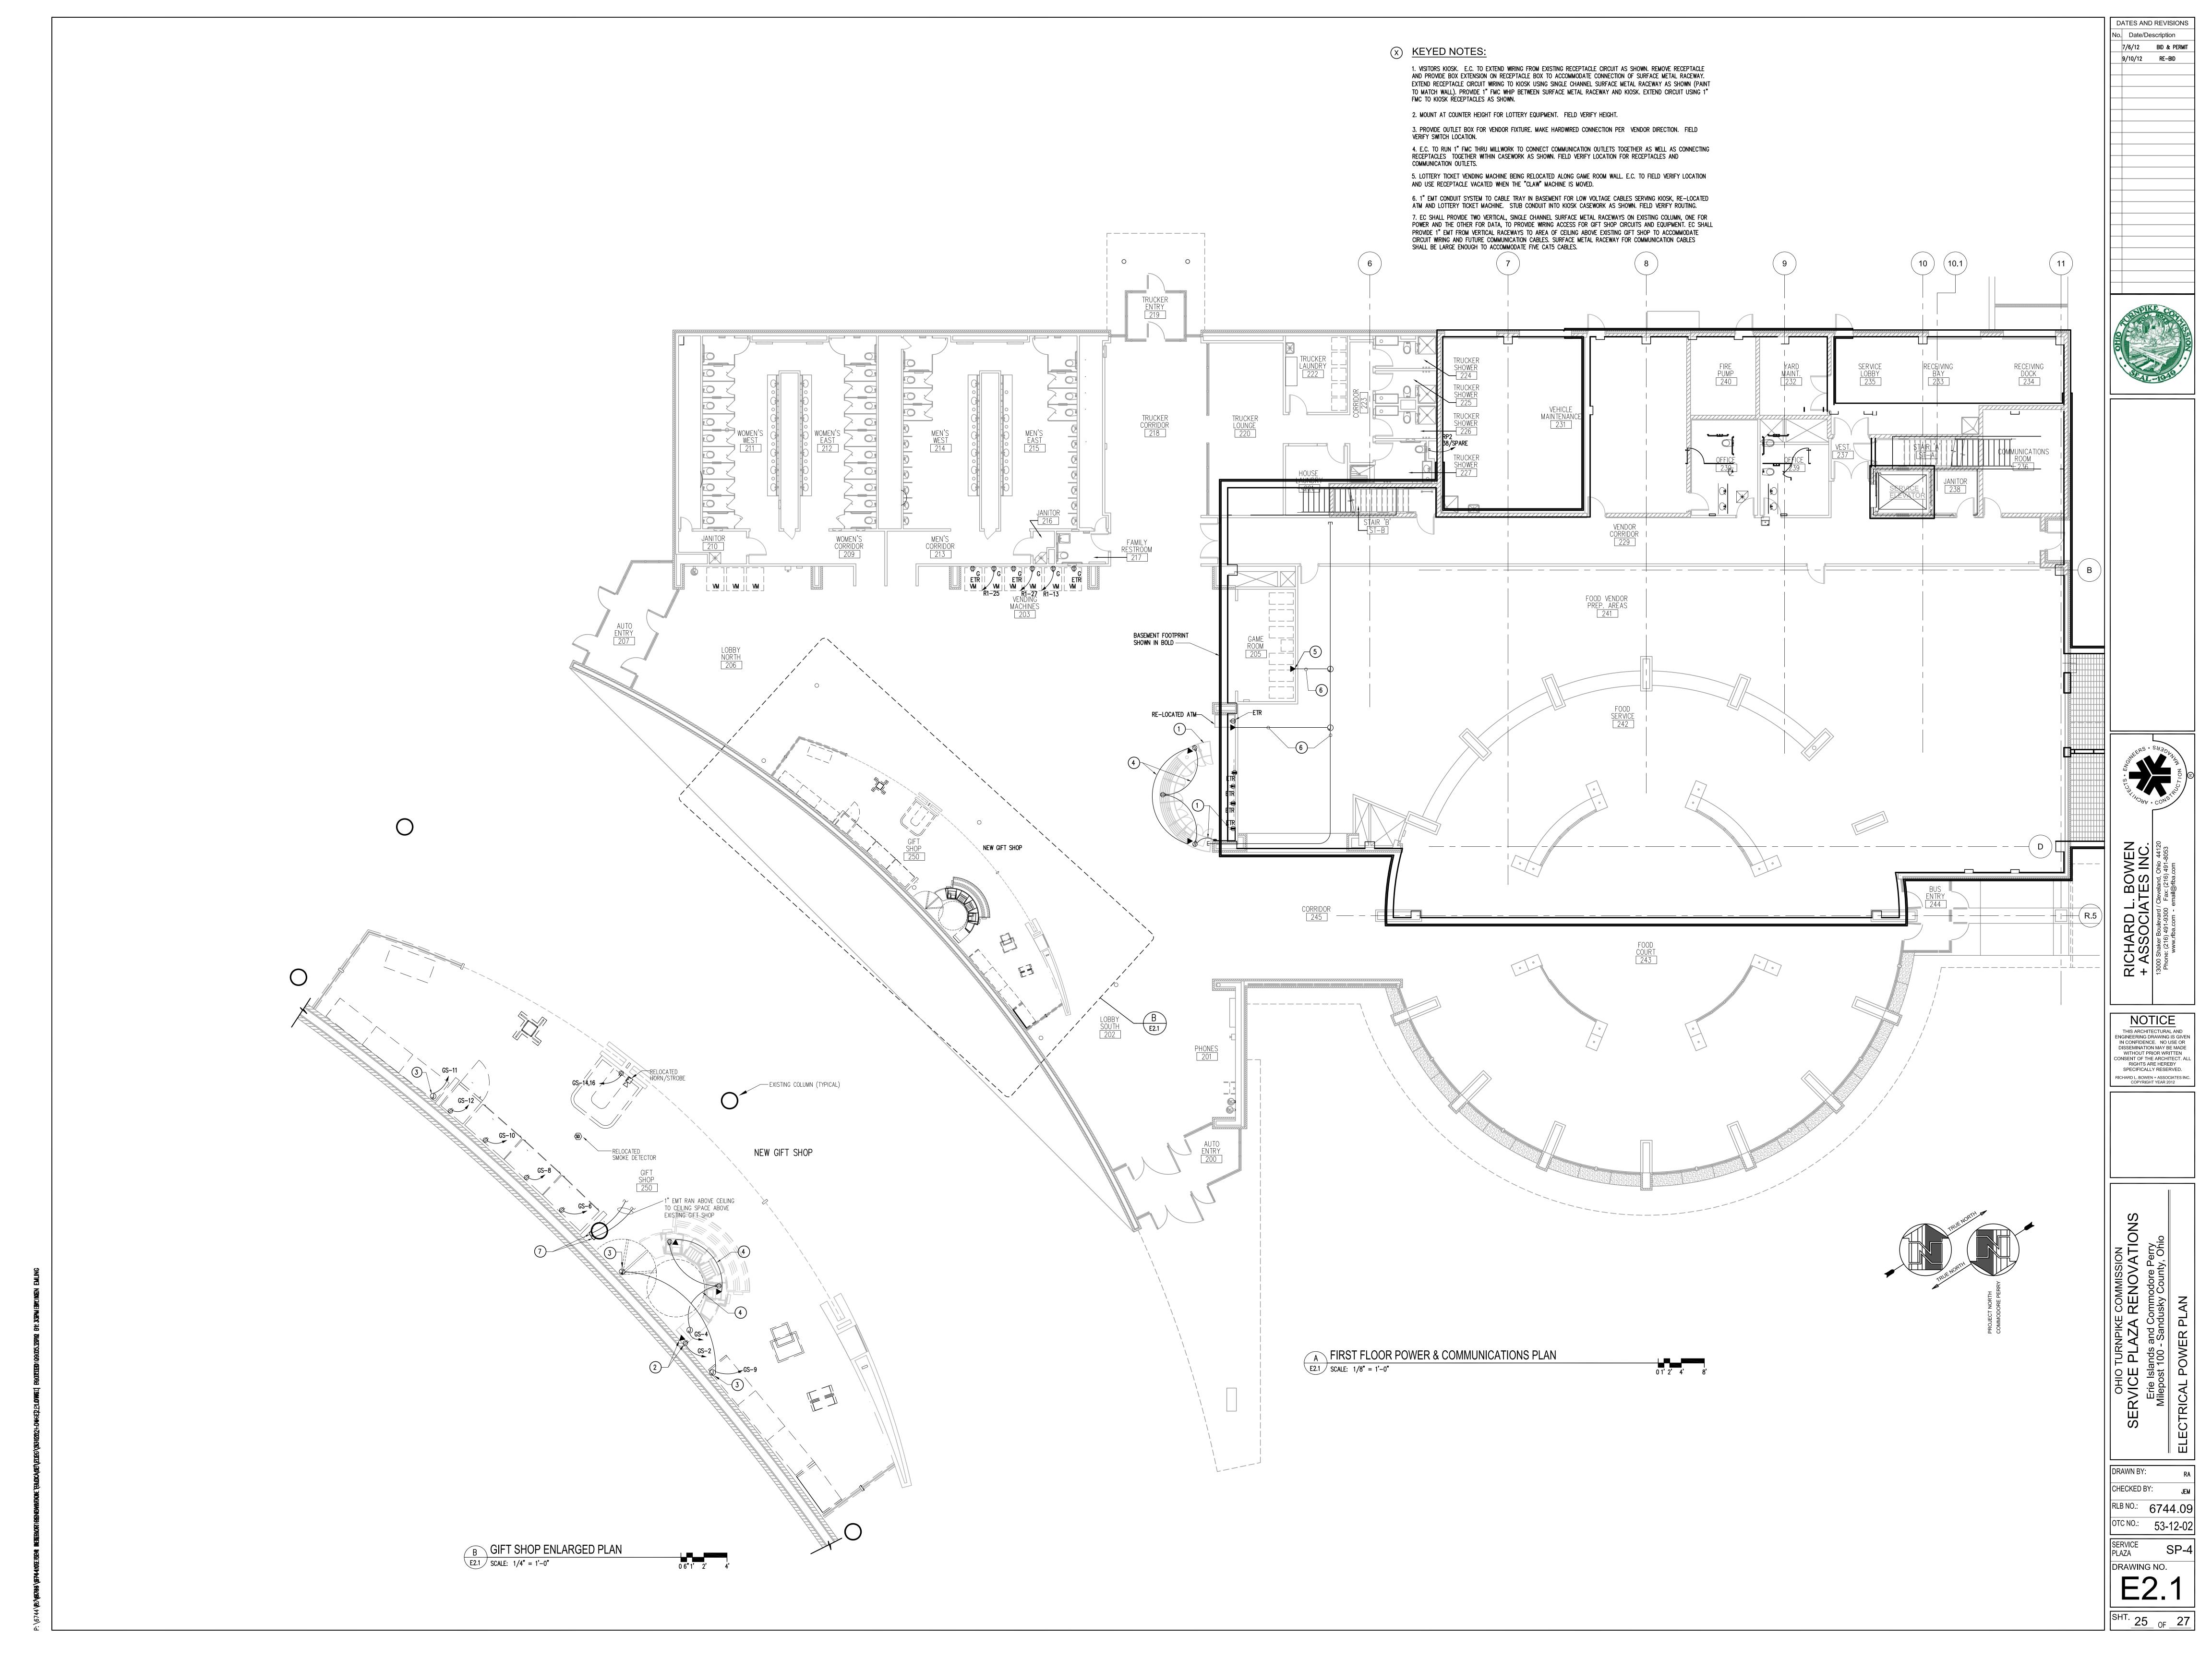
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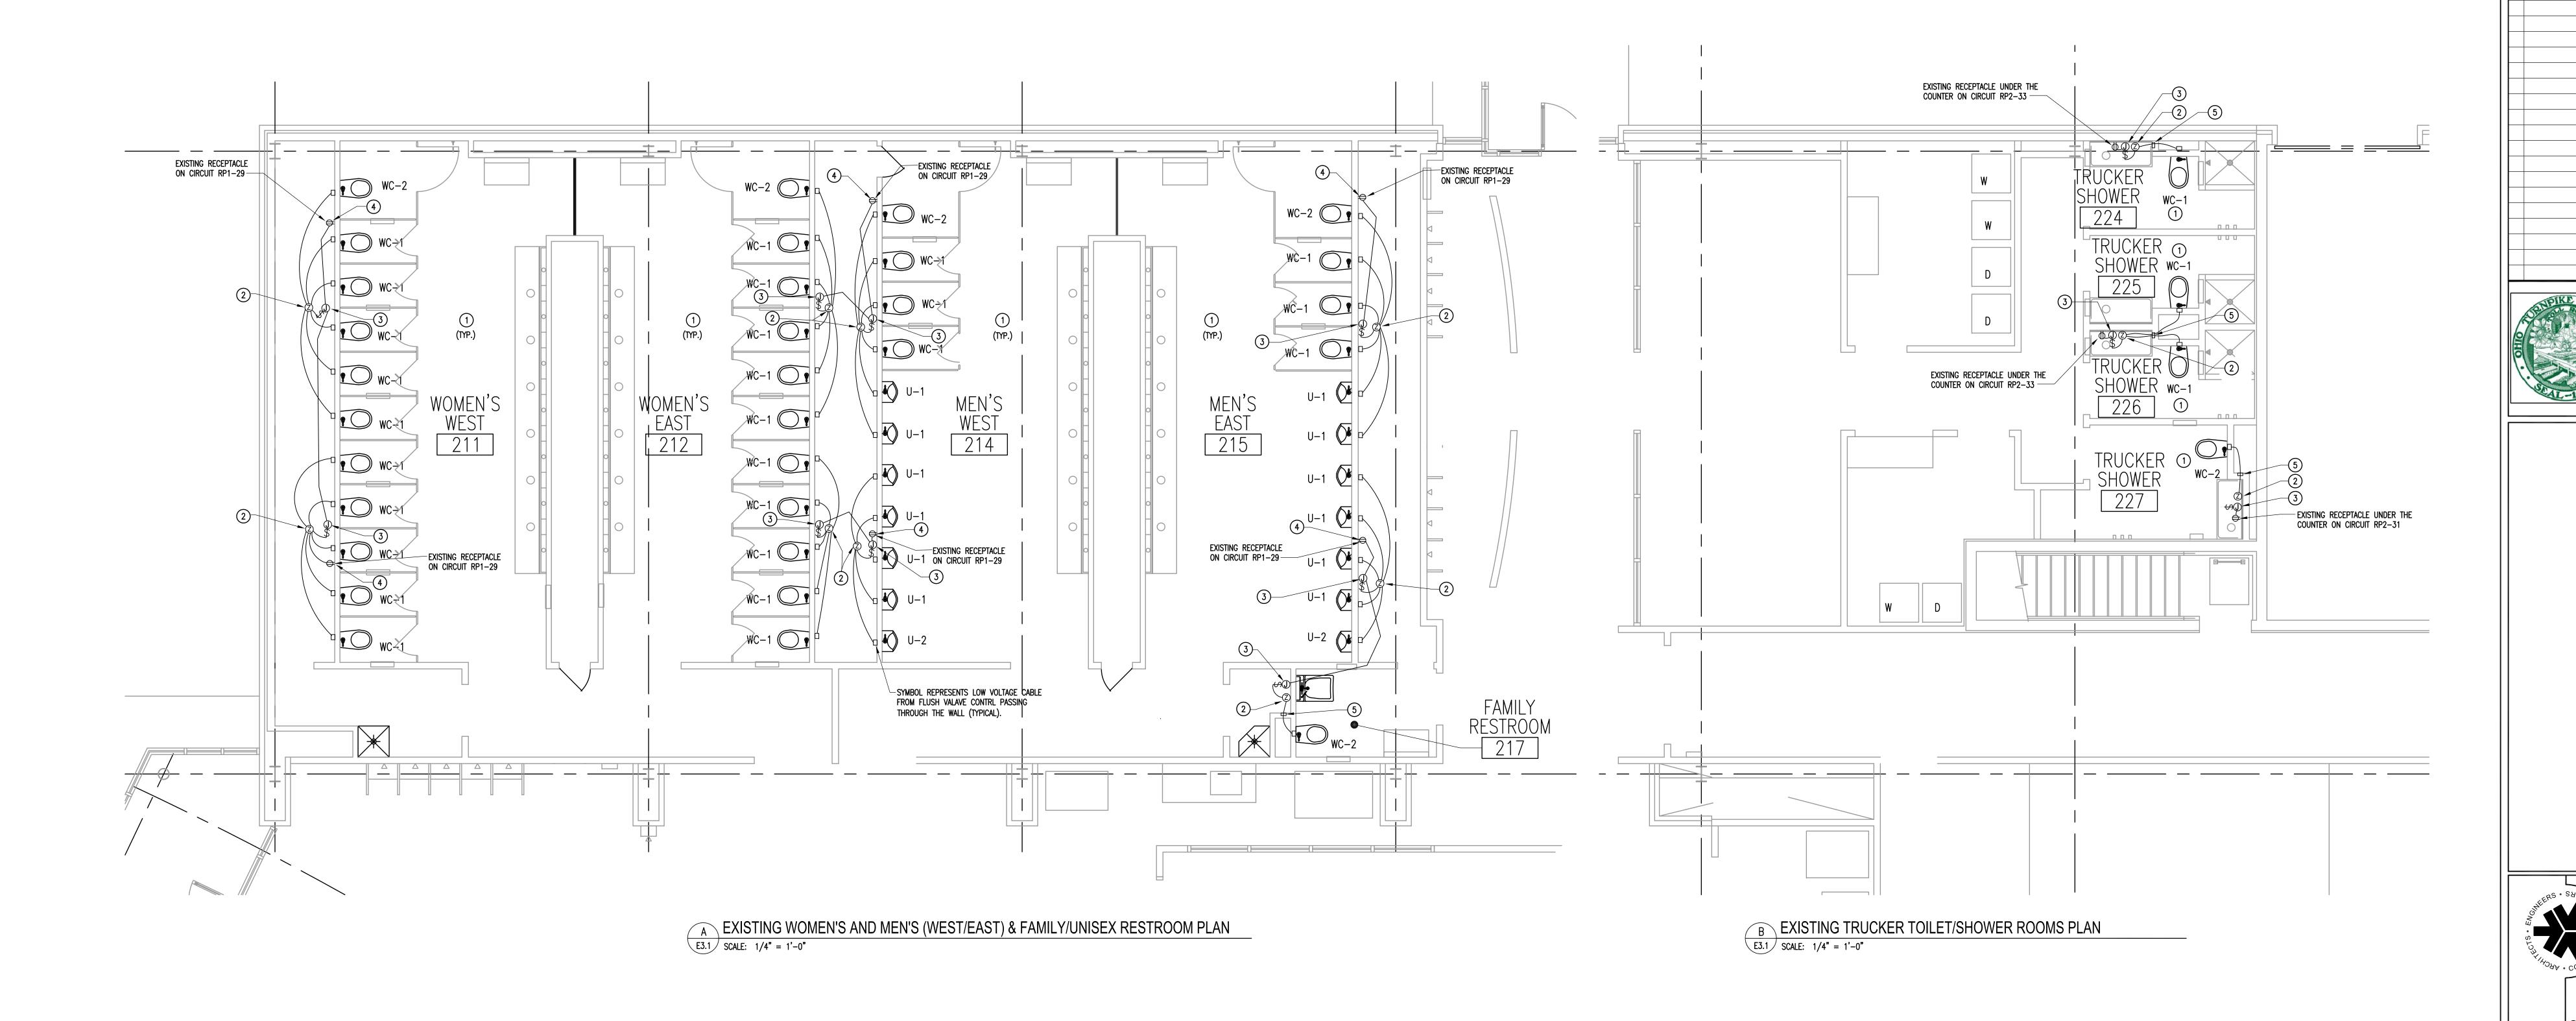
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## EXISTING PLUMBING FIXTURE EQUIPMENT LIST:

WC-1 KOHLER "KINGSTON" MODEL NO. K-4330, ELONGATED, WALL HUNG VITREOUS CHINA WATER CLOSET. ZURN MODEL NO. ZR6000XL-WS1 SENSOR OPERATED, BATTERY-POWERED FLUSH VALVE. CHURCH MODEL NO. 9500C WHITE OPEN FRONT TOILET SEAT WITH SELF-SUSTAINING CHECK HINGE. W/ JAY R. SMITH #M40 WIDE PIPE CHASE BRACKETS.

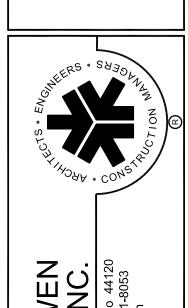WC-2 SAME AS WC-1 EXCEPT RIM IS 17" AFF.

<u>WC-3</u> SAME AS WC-2 EXCEPT ZURN MODEL NO. Z-6000XL-WS1 FLUSH VALVE.

<u>U-1</u> KOHLER "BARDON SUPERIOR" MODEL NO. K-4960-ET WALL HUNG, VITREOUS CHINA URINAL. ZURN MODEL NO. ZR6003XL-WS1 SENSOR OPERATED, BATTERY-POWERED FLUSH VALVE.
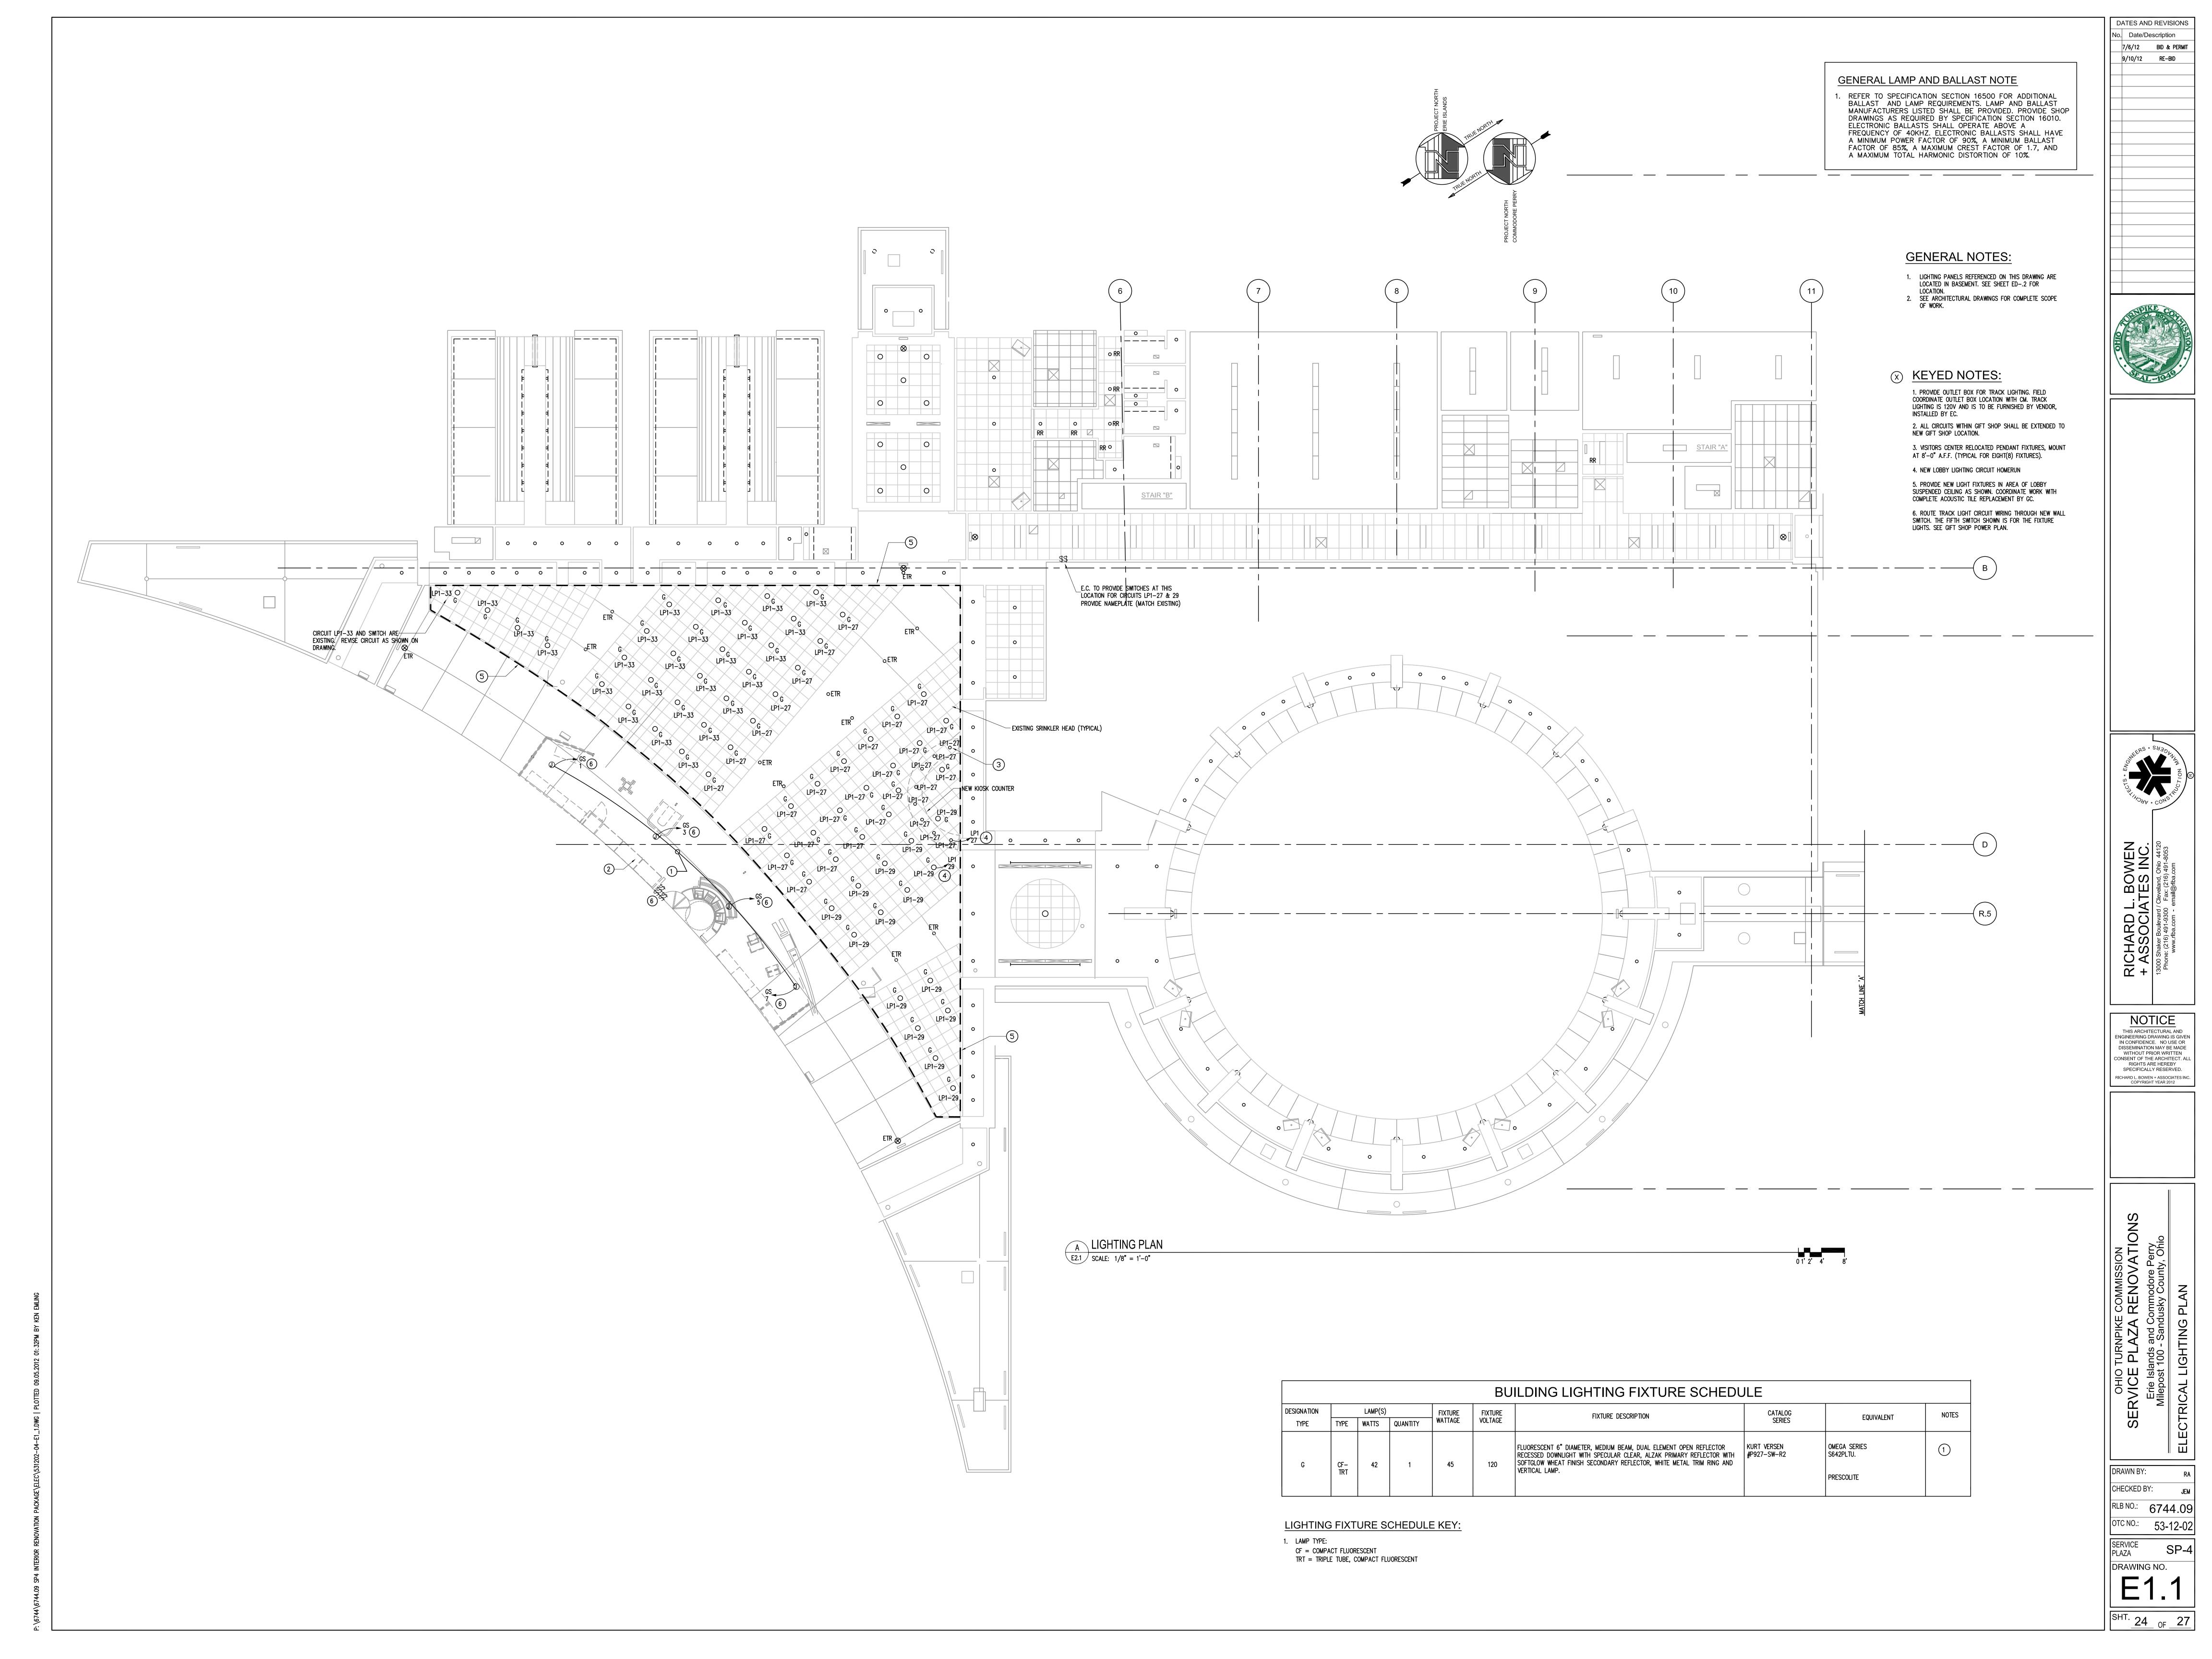
<u>-2</u> KOHLER "BARDON SUPERIOR" MODEL NO. K-4960-ET WALL HUNG, VITREOUS CHINA URINAL MOUNTED AT HANDICAPPED HEIGHT. ZURN MODEL NO. ZR6003XL-WS1 SENSOR OPERATED FLUSH VALVE.

# PLUMBING NOTES:

PROVIDE FOLLOWING PARTS TO CONVERT THE BATTERY OPERATED EXISTING WATER CLOSET

FLUSH VALVE INTO A HARD-WIRED FLUSH VALVE:
- PEMS6000-HYM-IS ACTUATOR WITH INTEGRAL SENSOR AND MANUAL PUSH-BUTTON OVERRIDE.

P6000-ECA-WSI-CS TRIPLE FILER DIAPHRAGM.P6000-HW6 HARD-WIRED POWER CONVERTER.

PROVIDE FOLLOWING PARTS TO CONVERT THE BATTERY OPERATED EXISTING URINAL FLUSH VALVE INTO A HARD-WIRED FLUSH VALVE:

- PEMS6000-HYM-IS ACTUATOR WITH INTEGRAL SENSOR AND MANUAL PUSH-BUTTON OVERRIDE.
- P6000-EUA-WS1 DIAPHRAGM.

- P6000-HW6 HARD-WIRED POWER CONVERTER.

PROVIDE ZURN #ZEMS6000AV-WSI-IS WATER CLOSET FLUSH VALVE AND ZURN #ZEMS6003AV-WS1-IS URINAL FLUSH VALVE WHERE FLUSH VALVE SHALL BE REPLACED

(FIELD VERIFY).

PROVIDE (4) EXTRA REPLACEMENT PART SETS FOR WATER CLOSET FLUSH VALVE AND (2) SETS FOR URINAL FLUSH VALVE FOR FUTURE OTC USED.

# X KEYED NOTES:


#### 1. PROVIDE 120V POWER TO POWER NEW HARD-WIRED FLUSH

2. ZURN P6000-HW6 POWER CONVERTER PROVIDES 7.6VDC LOW VOLTAGE POWER FOR UP TO EIGHT FLUSH VALVES FROM 120 VOLT SOURCE. POWER CONVERTER IS FURNISHED BY GENERAL CONTRACTOR, INSTALLED BY ELECTRICAL CONTRACTOR, INCLUDING LOW VOLTAGE CABLES. GENERAL CONTRACTOR WILL PROVIDE PIPE THROUGH THE WALL FOR LOW VOLTAGE CABLES. EC SHALL PROVIDE BOX TO CONTAIN ALL LOW VOLTAGE SPLICES (TYPICAL).

3. PROVIDE 120V COVERED OUTLET BOX ON WALL ADJACENT TO ZURN POWER CONVERTER, BOX SHALL HAVE DISCONNECT SNAP SWITCH IN COVER. PROVIDE LABEL ON COVER READING "FLUSH VALVE POWER". (TYPICAL). EC SHALL MAKE HARD-WIRED CONNECTION BETWEEN OUTLET BOX AND ZURN POWER CONVERTER.

4. EXISTING RECEPTACLE CONNECTED TO CIRCUIT AS SHOWN. EC SHALL EXTEND 120 VOLT CIRCUIT FROM EXISTING RECEPTACLE TO NEW 120 VOLT SWITCHED OUTLET BOXES FOR ZURN POWER CONVERTERS. PROVIDE A BOX EXTENSION ON EXISTING RECEPTACLE BOX TO ACCOMMODATE CONNECTION TO EXISTING RECEPTACLE CIRCUIT.

5. EC SHALL FISH LOW VOLTAGE CABLES THROUGH THE PLUMBING CHASE IN OPEN FASHION. EC SHALL PROVIDE A MASONRY TYPE ELECTRICAL BOX IN EXISTING PLUMBING WALL TO ACCOMMODATE LOW VOLTAGE SPLICES AND PASSAGE OF LOW VOLTAGE CABLES THROUGH THE EXISTING PLUMBING WALL.

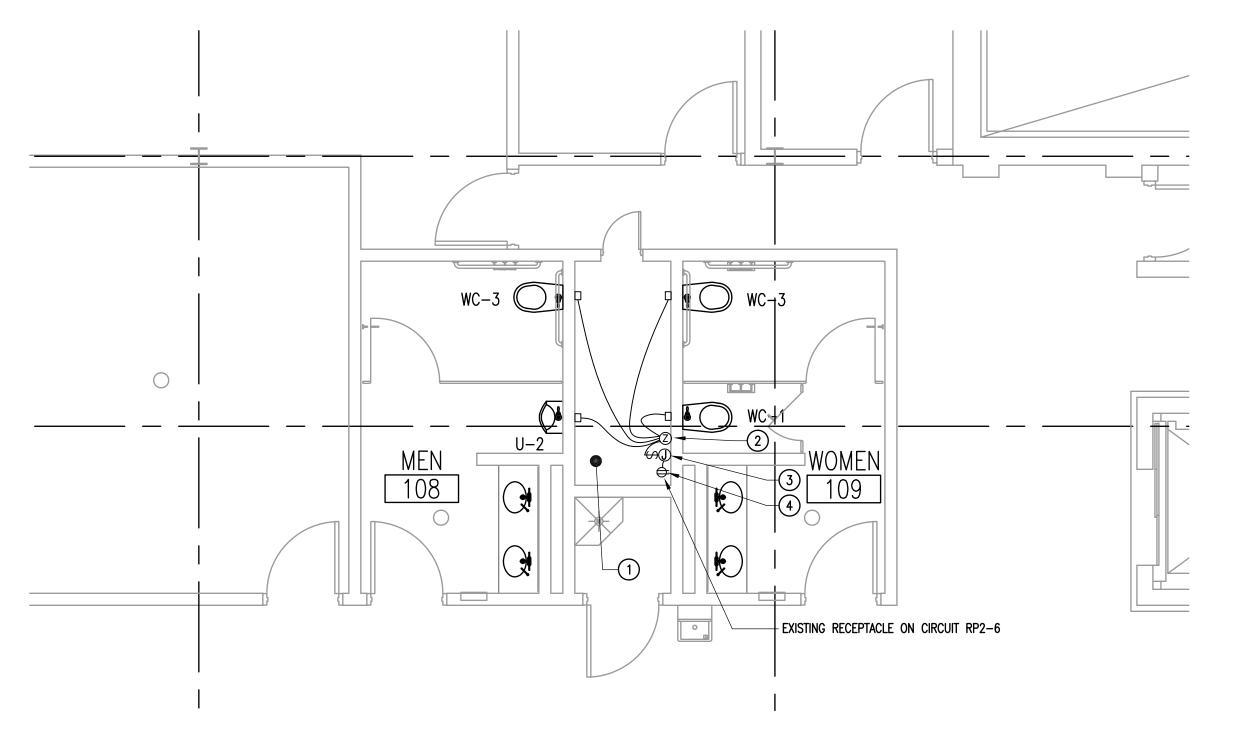

C EXISTING BASEMENT TOILET/SHOWER ROOM PLAN

E3.1 SCALE: 1/4" = 1'-0"

NZA KENOVALIONS
and Commodore Perry
Sandusky County, Ohio

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RLB NO.: 6744.09

OTC NO.: 53-12-02

SERVICE CD. 4

DRAWING NO.

E3.1

SHT. 26 OF 27

NOTE: EXISTING CIRCUITING SHOWN IN PANEL SCHEDULES WERE TAKEN FROM RECORD DRAWINGS AND CASUAL FIELD OBSERVATION AT THE ERIE ISLANDS SERVICE PLAZA AND IS NOT INTENDED TO BE EXACT.

**ABBREVIATIONS** 1PH SINGLE PHASE 3PH THREE PHASE AFF ABOVE FINISHED FLOOR AFG ABOVE FINAL GRADE AHJ AUTHORITY HAVING JURISDICTION AL ALUMINUM BFG BELOW FINAL GRADE BRKR CIRCUIT BREAKER CKT CIRCUIT COORD COORDINATE CLG CEILING CU COPPER EC ELECTRICAL CONTRACTOR EMT ELECTRICAL METALLIC TUBING ETR EXISTING TO REMAIN EWH ELECTRIC WATER HEATER EWC ELECTRIC WATER COOLER EXIST EXISTING FLR FLOOR FMC FLEXIBLE METAL CONDUIT GC GENERAL CONTRACTOR GND GROUND HGT HEIGHT IAW IN ACCORDANCE WITH IG ISOLATED GROUND LL LANDLORD LCP LIGHTING CONTROL PANEL LT, LTS LIGHT, LIGHTS MC MECHANICAL CONTRACTOR MGT MOUNTED/MOUNTING NL NIGHT LIGHT OCP OVERCURRENT PROTECTION PNL PANEL/PANELBOARD POC POINT OF CONTACT REC RECEPTACLE REX REMOVE EXISTING DEVICE COMPLETE RGS RIGID GALVANIZED STEEL CONDUIT RR REMOVE AND RELOCATE SCHD SCHEDULE UNO UNLESS NOTED OTHERWISE WP WEATHERPROOF XFMR TRANSFORMER

SYMBOL	DESCRIPTION
R1-3	BRANCH CIRCUIT HOMERUN TO PANEL 'R1', CIRCUIT #3 (TYPICAL)
$\square$	DRY-TYPE TRANSFORMER, HANG FROM STRUCTURE
<b>D</b>	277/480V 3ø 4W ELECTRICAL PANEL
	120/208V 3ø 4W ELECTRICAL PANEL
Ф	DUPLEX RECEPTACLE, NEMA 5-20, G INDICATES GFCI TYPE. MOUNT 18"AFF UNO
Ф	DUPLEX RECEPTACLE, NEMA 5-20. MOUNT 18"AFF UNO
<b>#</b>	QUADPLEX RECEPTACLE, NEMA 5-20.
\$ <b>a</b>	SWITCH, SINGLE POLE, 20A, 125/277V. SUBSCRIPT INDICATES SWITCHING SCHEME.
	DISCONNECT SWITCH, VOLTAGE AS REQUIRED, AMPACITY AS NOTED
<b>J</b>	J-BOX. CEILING OR WALL MTD. SIZE AND TYPE AS REQUIRED
•	COMMUNICATION OUTLET. PROVIDE 3"X2"X2-1/8" BOX WITH IVORY COVER PLATE CONTAINING FOUR RJ-45 NON-KEYED OPENINGS. FIELD COORDINATE FINAL LOCATION OF COMMUNICATION BOXES. COMMUNICATION CABLES BY OTHERS. EC SHALL PROVIDE 1" EMT EMTPY CONDUIT SYSTEM FOR COMMUNICATIONS CABLES AS SHOWN AND NOTED ON PLANS. EMPTY CONDUIT SYSTEM SHALL TERMINATE AT EXISTING CABLE TRAY IN BASEMENT. PROVIDE PULL STRING IN ALL COMMUNICATON CONDUITS, ENTIRE LENGTH.

#### GENERAL ELECTRICAL NOTES:

1. ALL CONDUIT PENETRATIONS THROUGH FIRE RATED WALLS, FLOORS, OR SHAFTS SHALL BE SEALED IN ACCORDANCE WITH SPECIFICATION SECTION 16050. CONDUITS ENTERING BUILDING FROM UNDERGROUND EXTERIOR SHALL HAVE "LINK SEAL" PRODUCTS, OR EQUAL, AS DIRECTED BY ARCHITECT. (EMPTY CONDUITS SHALL BE SEALED AND CAPPED).

2. CONTRACTOR SHALL COORDINATE LOCATIONS OF ALL INTERIOR LIGHTING FIXTURES AND CEILING MOUNTED DEVICES WITH THE ARCHITECTURAL REFLECTED CEILING PLANS, ELEVATIONS, SECTIONS AND DETAILS. COORDINATE LOCATIONS OF RECEPTACLES AND OTHER WALL MOUNTED DEVICES WITH THE ARCHITECTURAL WALL ELEVATIONS AND FINISHES

3. THE ROUTING OF ALL SURFACE MOUNTED/EXPOSED CONDUIT IN UNFINISHED AREAS (OR WHERE NOTED ON THE DRAWINGS) SHALL BE COORDINATED WITH, AND SHALL BE APPROVED BY THE ARCHITECT PRIOR TO INSTALLATION.

4. CONTRACTOR SHALL VERIFY THE EXACT LOCATION OF MECHANICAL EQUIPMENT WITH THE MECHANICAL CONTRACTOR. EXACT ELECTRICAL REQUIREMENTS SHALL BE VERIFIED IN THE FIELD WITH THE EQUIPMENT'S NAMEPLATE DATA. THE CONTRACTOR SHALL MAKE APPROPRIATE ADJUSTMENTS TO WIRE AND FUSE SIZES IN ACCORDANCE WITH THE NAMEPLATE DATA.

5. THE ELECTRICAL WIRING, CONNECTION AND PROTECTION REQUIREMENTS FOR OWNER FURNISHED EQUIPMENT SHALL BE VERIFIED IN THE FIELD WITH THE OWNER'S EQUIPMENT SUPPLIER, AND WITH THE NAMEPLATE DATA. FURNISH THE PROPER NEMA RECEPTACLE CONFIGURATIONS, CONNECTIONS, AND CIRCUITS IN ACCORDANCE WITH THE MANUFACTURER'S RECOMMENDATIONS.

6. ALL BRANCH CIRCUITS AND FEEDERS SHALL CONTAIN AN INSULATED GROUNDING CONDUCTOR IN ACCORDANCE WITH SPECIFICATION SECTION 16400. NEUTRAL CONDUCTORS IN RECEPTACLE CIRCUITS SERVING DATA EQUIPMENT LOADS SHALL NOT BE SHARED IN ACCORDANCE WITH SPECIFICATION SECTION 16050.

7. THE DISCONNECTING MEANS FOR ALL MOTORS AND EQUIPMENT SHALL BE INSTALLED IN A "READILY ACCESSIBLE" LOCATION AND SHALL HAVE PROPER WORKING SPACE AS DEFINED IN N.E.C. ARTICLE 100 AND 110.

8. UTILIZATION OF THE PHRASE "PROVIDED BY" WITHIN THE CONTEXT OF THESE DOCUMENTS SHALL EXPLICITLY REPRESENT "FURNISHED AND INSTALLED BY".

EXPOSED WORK IN PUBLIC AREAS WITHOUT CM APPROVAL.

9. EXPOSED NON-METALLIC CONDUIT IS NOT PERMITTED AT INTERIOR LOCATIONS. ALL NEW WORK SHALL BE CONCEALED TO GREATEST EXTENT PRACTICAL. DO NOT INSTALL

PANI	ELBOARD LOADING SCHEDU	LE	VOLTS	120/208	3	PANEL		LP1		LOCAT	ION: BASEMENT	
SURI	ACE MOUNTED		PHASE	3		10 KAIC				EXISTING (ON EMERGENCY PWR)		
GRO	UND BAR	WIRE 4			MAINS AMPS		225/3 M.L.O.					
CKT	LOAD					_					LOAD	CK
No.	DESCRIPTION	VA	AMPS	POLE	Α	В	С	POLE	AMPS	VA	DESCRIPTION	No
1	MENS RR LTG.	700	20	1	1700		l	1	20	1000	BASEMENT LTG.	2
3	MENS RR LTG.	1200	20	1		1700		1	20	500	PHONES BUS. CTR. LTG.	4
5	RR ENT. LTG.	500	20	1			1300	1	20	800	TR INFO,GAME,VEND LTG.	6
7	WOMENS RR LTG.	700	20	1	1700			1	20	1000	PATRON ENT.	8
9	WOMEN RR LTG.	1200	20	1		1700		1	20	500	LOBBY TRACK	10
11	TRUCKERS ENT.	700	20	1			700	1	20		SPARE	12
13	TRUCKERS ENT.	1200	20	1	1700			1	20	500	LOBBY TRACK	14
15	SPARE		20	1		500		1	20	500	S.W. VENDING RCPT.	16
17	FOOD COURT CORR. LTG.	600	20	1			1100	1	20	500	S.W. VENDING RCPT.	18
19	FOOD COURT CORR. LTG.	1100	20	1	2100			1	20	1000	FOOD CT. DOWN LTG.	20
21	FOOD COURT CORR. LTG.	1100	20	1		1800		1	20	700	FOOD CT. DOWN LTG.	22
23	FOOD COURT CORR. LTG.	1100	20	1			1800	1	20	700	FOOD CT. DOWN LTG.	24
25	FOOD COURT CORR. LTG.	1100	20	1	2100			1	20	1000	FOOD CT. DOWN LTG.	26
27	LOBBY LTG.	1500	20	1		2500		1	20	1000	FOOD CT. DOWN LTG.	28
29	LOBBY LTG.	1500	20	1			2500	1	20	1000	CENTER FOOD CT. LTG.	30
31	GIFT SHOP LTG.	1000	20	1	2000			1	20	1000	CENTER FOOD CT. LTG.	32
33	LOBBY LTG.	1100	20	1		1350		1	20	250	TRACK LTG.	34
35	CANOPY COL. LTG.	700	20	1			2000	1	20	1300	FOOD CT. & CANOPY LTG.	36
37					1000			1	20	1000	S.W. VENDING RCPT.	38
39	ASCO TRANSFER SWITCH		70	3		1000		1	20	1000	S.W. VENDING RCPT.	40
41							1000	1	20	1000	EXIT/NL	42
	TOTAL CONNECTED LOAD			33250	12300	10550	10400					
	TOTAL AMPERES			92.4	102.5	87.9	86.7					
				•	•	•	•	-				

PAN	ELBOARD LOADING SCHEDUI	VOLTS	120/208	3	PANEL		RP1		LOCATION: BASEMENT			
SURI	FACE MOUNTED	PHASE	3		10 KAIC	;			EXISTING (ON EMERGENCY PWR)			
GRO	UND BAR	WIRE	4		MAINS AMPS 225/3			25/3 M.L.O.				
CKT	LOAD					1				l	LOAD	СКТ
No.	DESCRIPTION	VA	AMPS	POLE	Α	В	С	POLE	AMPS	VA	DESCRIPTION	No.
1	BASEMENT ANNEX RCPT.	700	20	1	1500			1	20	800	ADA DOORS	2
3	BASEMENT ANNEX RCPT.	1200	20	1		2000		1	20	800	LOBBY RCPT.	4
5	EXT. RCPT./ADA DOORS	600	20	1			1200	1	20	600	LOBBY RCPT.	6
7	GAME RM. RCPT.	1000	20	1	2000	] '		1	20	1000	COPIER	8
9	GAME RM. RCPT.	1200	20	1		1700		1	20	500	FAX MACHINE	10
11	VENDING MACHINES	1000	20	1			1500	1	20	500	ATM	12
13	VENDING MACHINES	1000	20	1	1800	] '		1	20	800	M & W RESTRM.	14
15	VENDING MACHINES	1000	20	1		1800		1	20	800	M & W RESTRM.	16
17	VENDING MACHINES	1000	20	1			1600	1	20	600	M & W RESTRM.	18
19	VENDING MACHINES	1000	20	1	2000	]		1	20	1000	VENDING MACHINE	20
21	ELECTRIC WATER COOLER	1000	20	1		2000		1	20	1000	WOMENS RR FLUSH VALVE	22
23	ELECTRIC WATER COOLER	1000	20	1			2000	1	20	1000	MENS RR FLUSH VALVE	24
25	VENDING RCPT.	1000	20	1	2000			1	20	1000	WASHER	26
27	VENDING RCPT.	1000	20	1		2000		1	20	1000	WASHER	28
29	PIPE CHASE RCPT.	800	20	1		_	1300	1	20	500	DRYER	30
31	COUNTER DOOR MTR.	1000	20	1	1500			1	20	500	DRYER	32
33	EF1 & EF2	1400	20	1		2400		1	20	1000	WASHER	34
35	EF3 & EF7	700	20	1		_	1200	1	20	500	DRYER	36
37	RESTRM. SENSORS	500	20	1	700			1	20	200	TRUCKER FLUSH VALVE	38
39	RESTRM. SENSORS	500	20	1		500		1	20		SPARE	40
41	FIRE ALARM	1000	20	1			1000	1	20		SPARE	42
								-				
	TOTAL CONNECTED LOAD				11500	12400	9800					
	TOTAL AMPERES		93.6	95.8	103.3	81.7						


PANI	ELBOARD LOADING SCHEDU	VOLTS	120/208		PANEL GS				LOCATION: BASEMENT			
SURI	FACE MOUNTED	PHASE 3			10 KAIC				EXISTING (ON EMERGENCY PWR)			
GRO	UND BAR	WIRE 4			MAINS AMPS		50/3 MCB					
CKT	LOAD					ı					LOAD	CKT
No.	DESCRIPTION	VA	AMPS	POLE	Α	В	С	POLE	AMPS	VA	DESCRIPTION	No.
1	GIFT SHOP LTG. 16' TRACK	1200	20	1	2200			1	20	1000	GIFT SHOP RCPT.	2
3	GIFT SHOP LTG. 16' TRACK	1200	20	1		2200		1	20	1000	GIFT SHOP RCPT.	4
5	GIFT SHOP LTG. 16' TRACK	1200	20	1			2200	1	20	1000	GIFT SHOP RCPT.	6
7	GIFT SHOP LTG. 16' TRACK	1200	20	1	2200			1	20	1000	GIFT SHOP RCPT.	8
9	DISPLAY LTG.	700	20	1		1700		1	20	1000	GIFT SHOP RCPT.	10
11	DISPLAY LTG.	700	20	1			1700	1	20	1000	GIFT SHOP RCPT.	12
13	SPARE		30	1	1000			2	20*	1000	GIFT SHOP RCPT.	14
15	SPACE					1000				1000		16
17	SPACE						0	1	20		SPARE	18
19	SPACE				0			1	20		SPARE	20
21	SPACE					0		1	20		SPARE	22
23	SPACE						0				BLANK	24
* IND	ICATES NEW CIRCUIT BREAK	KER IN E	EXISTING	SPACE	=			-				
	TOTAL CONNECTED LOAD				5400	4900	3900					
	TOTAL AMPERES	39.4	45.0	40.8	32.5							

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CE PLAZA RENOVATIONS

Islands and Commodore Perry

Jost 100 - Sandusky County, Ohio

SERVICE PLAZA R
Erie Islands and Com
Milepost 100 - Sandusl

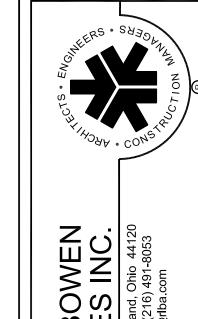CHECKED BY: JEM

RLB NO.: 6744.09

OTC NO.: 53-12-02

SERVICE PLAZA SP-ADRAWING NO.

T. 27 OF \_\_\_\_\_